

ELECTRICAL PLAN A

SCALE: 1/4" = 1'-0"

MODTECH INC.

2830 BARRETT AVENUE PERRIS, CALIF. 92572 PROJECT NUMBER: 4134,4153, 4173, 4203 © MODTECH, INC. 2001 4207, 4215, 4250

OVER OBSTRUCTION


TOP OF DEVICE

4284,4302,4350 4304, 4347, 4373, 4422 4506

DRAWN BY: M. ANDERSEN DATE: APR 15 2002 CHECKED BY: 4012-121 DATE: 04-16-0Z MODIECH Index No.

STKP-62

24'x40' STANDARD

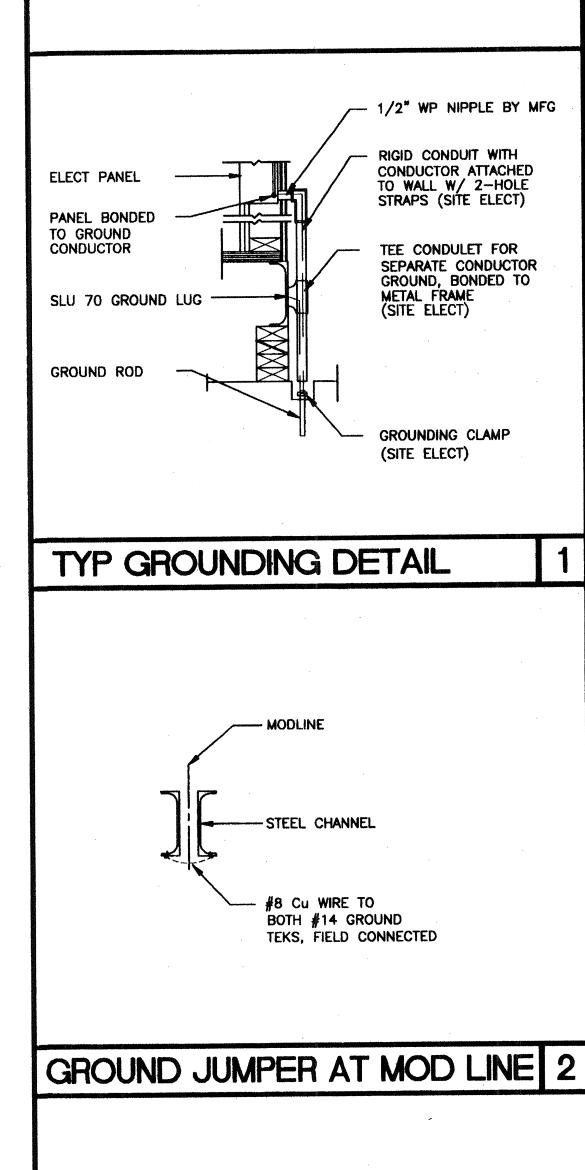

NOTES 1. SCHOOL EQUIPMENT ANCHORAGE

ELECTRICAL LEGEND

2'x4' 4 TUBE FLUORESCENT LIGHT FIXTURE

EXTERIOR LIGHT FIXTURE AT +93" AFF

3WAY SWITCH AT +48" AFF UON

3/4" CO TO CO OR . PULLSTRING

4SD J-BOX FOR FIRE ALARM STROBE AT +80" AFF 3/4" CO TO Q PULLSTRING

4SD J-BOX FOR FIRE ALARM HORN AT +96" AFF

WEATHER PROOF GUTTER BOX (6"x6"x4") AT

NIPPLE POC, GND JUMPER BY SITE ELECT

FILE NO. 15-6

4SD J BOX FOR HEAT DETECTOR (ATTIC) *

4SD J BOX FOR SMOKE DETECTOR (ATTIC) *

AGENCY TRACKING NO. 63321-201

IDENTIFICATION STAMP DIV. OF THE STATE ARCHITECT OFFICE OF REGULATION SERVICES

AC__FLS_FYSS FM SEP 1 3 2016

3/4" CO TO ____. PULLSTRING

CLOCK AT +90" AFF

DUPLEX WALL RECEPTACLE 15A 125V 3-WIRE AT +18" AFF UON

4SD J-BOX FOR FIRE ALARM PULL STATION AT +48" AFF, TO C

+18" AFF RECEIVE 3/4" CO FROM FA DEVICE, PULLSTRING

ELECTRICAL PANEL AT +60" AFF TO CENTERLINE 1 1/4" POWER

SWITCH AT +48" AFF

HVAC UNIT (HV)

- 1/2" WP NIPPLE BY MFG

RIGID CONDUIT WITH CONDUCTOR ATTACHED

TO WALL W/ 2-HOLE

STRAPS (SITE ELECT)

TEE CONDULET FOR SEPARATE CONDUCTOR

GROUNDING CLAMP (SITE ELECT)

-STEEL CHANNEL

BOTH #14 GROUND TEKS, FIELD CONNECTED

METAL FRAME

(SITE ELECT)

GROUND, BONDED TO

THE FOLLOWING IS FOR THE ARCHITECTS INFORMATION ONLY: THE SEISMIC ANCHORAGE OF ELECTRICAL EQUIPMENT SHALL CONFORM TO CCR TITLE 24, SECTION 1632A AND TABLE 16A-O. ANCHORAGE DETAILS FOR ROOF/FLOOR MOUNTED EQUIPMENT WEIGHING LESS THAN 400 LBS & HUNG EQUIPMENT WEIGHING LESS THAN 20 LBS MAY BE OMITTED FROM THE PLANS.


ALL ELECTRICAL EQUIPMENT SHALL BE BRACED OR ANCHORED TO RESIST A HORIZONTAL FORCE ACTING IN ANY DIRECTION USING THE FOLLOWING CRITERIA:

EQUIPMENT ON STRUCTURE

20% OF OPERATING WEIGHT 30% OF OPERATING WEIGHT

FOR FLEXIBLY MOUNTED EQUIPMENT USE 4 TIMES THE ABOVE VALUES, AND FOR SIMULTANEOUS VERTICAL FORCE USE 1/3 TIMES THE HORIZONTAL FORCE. THE ABOVE VALUES ARE FOR AN IMPORTANCE FACTOR, I=1.0 AND SEISMIC ZONE, Z=4WHERE ANCHORAGE DETAILS ARE NOT SHOWN ON THE DRAWINGS THE FIELD INSTALLATION SHALL BE SUBJECT TO THE APPROVAL OF THE ARCHITECT AND THE FIELD ENGINEER OF THE OFFICE OF THE STATE ARCHITECT.

* 2. SMOKE AND HEAT DETECTORS SHOWN ARE FOR OPTIONAL AUTOMATIC DETECTION. IF ELECTED AS AN OPTION MODTECH WILL PROVIDE 4SD BOXES AND 3/4" CO MOUNTED ON UNDERSIDE OF ROOF PURLINS. DEVICES PROVIDED AND INSTALLED BY OTHERS

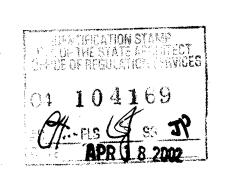

CBC 1998

C OF DEVICE

DEVICE MOUNTING

STANDARD (24'x40')

IDENTIFICATION STAMP
DIV. OF THE STATE ARCHITECT
OFFICE OF REGULATION SERVICES

PC-04

AC DEFISION TOOL

(909) 943-4014 (909) 940-0427

ELECTRICAL PLAN

Electrical Engineer's Seal REVISIONS

LEFT

1000 LOENSEL

FRONT