



LEFT SIDE ELEVATION

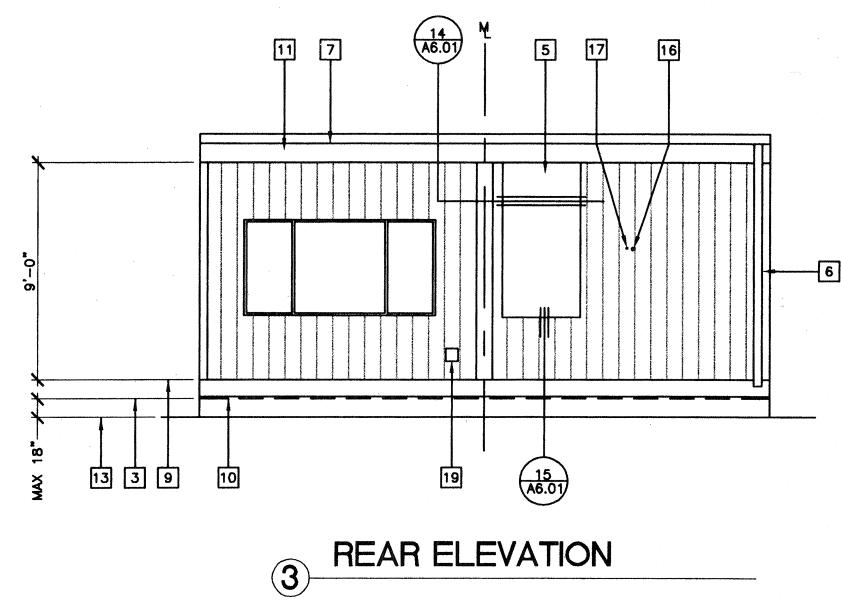

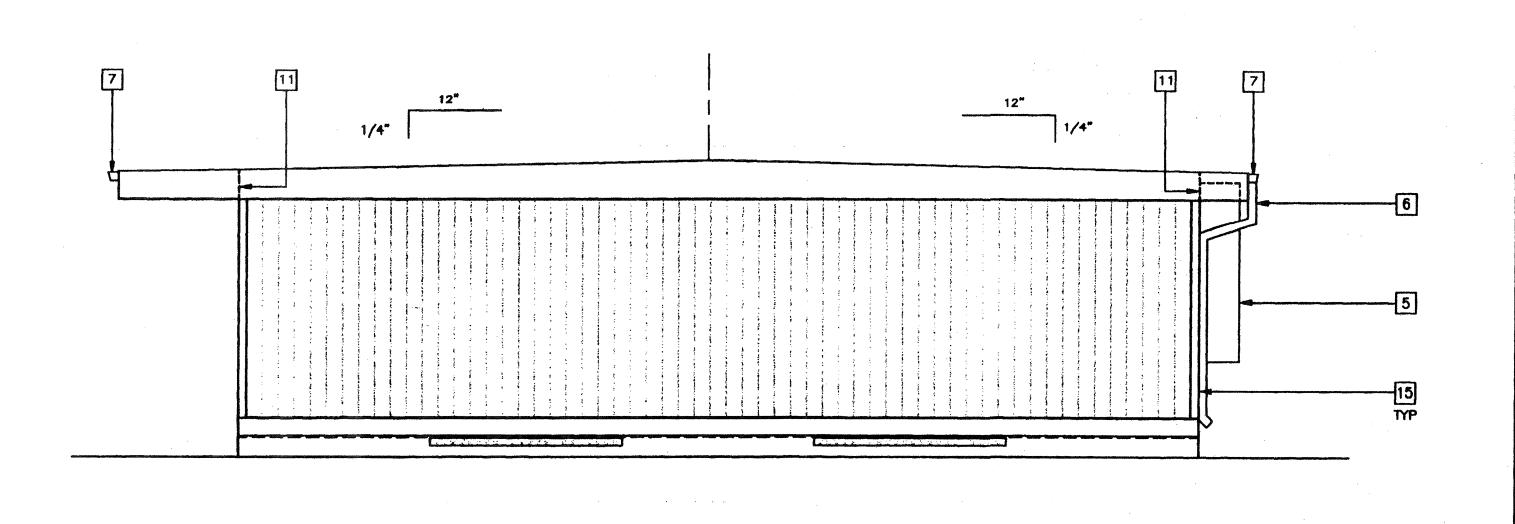

RIGHT SIDE ELEVATION


PC **CBC** 1998


EXTERIOR ELEVATIONS A/C


26 GA DUAL PITCH (24'x40') SCALE: 1/4" = 1'-0"


STKP-62

REVISIONS Electrical Engineer's Seal MCA MODIFIED FLOOR PLAN 04/15/02

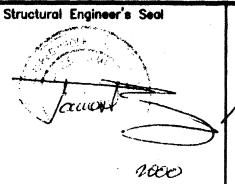

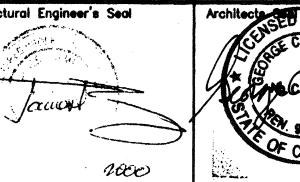

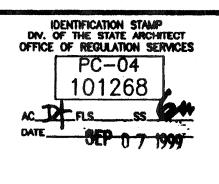

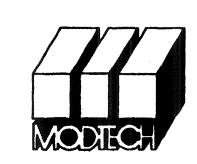

MODTECH INC.

2830 BARRETT AVENUE PERRIS, CALIF. 92572 PH (909) 943-4014 FAX (909) 940-0427

PROJECT NUMBER: 4134, 4161, 4203, 4207© MODTECH, INC. 2001 4215, 4302, 4304, 4347

DRAWN BY: M. ANDERSEN DATE: APR 15 2002

KEY NOTES

TOP OF SKIRTING

5 HVAC UNIT HV

4 RAMP AND LANDING - R1.01

FINISH FLOOR LINE

FLOOR BEAM STR

TOP OF COLUMN

COLUMN STR

ELECTRICAL STUB-OUT EL

GROUND STUB-OUT (EL)

GUTTER BOX EL

OCCUPANCY. 5/A5.01

STANDARD - 5/8" PLYWOOD SIDING

OPTIONAL - EXTERIOR PLASTER OVER LATH

FILE NO. 15-6

NOTES

FINISH GRADE

EXTERIOR LIGHT FIXTURE (EL)

TYPICAL EXTERIOR FINISH SEE EXTERIOR FINISH SCHEDULE BELOW.

DOWNSPOUT FASTEN TO BUILDING TYPICAL (3) PLACES - 16/A2.03

CONTINUOUS GUTTER WITH DOWNSPOUT (LOCATION OF DOWNSPOUT SHOWN ON ROOF PLAN)

FOUNDATION VENT (SEE FOUNDATION PLAN)

J-BOX FOR EXTERIOR FIRE ALARM HORN (EL)

SIGNAGE PROVIDED AND INSTALLED BY DISTRICT PRIOR TO

1.) IF HVAC UNIT IS LOCATED IN ANY PATH OF TRAVEL OR CIRCULATION AREA AND HEIGHT FROM GRADE TO BOTTOM OF UNIT EXCEEDS 27" PROTECTION MUST BE PROVIDED

EXTERIOR FINISH SCHEDULE

NOTE: SEE SPECIFICATIONS FOR DETAILED DESCRIPTION OF FINISH

OPTIONAL - 5/16" FIBER CEMENT BOARD WITH TEXTURED ELASTOMERIC COATING SYSTEM

AGENCY TRACKING NO. 63321-201

IDENTIFICATION STAMP DIV. OF THE STATE ARCHITECT OFFICE OF REGULATION SERVICES

03-117285

EXTERIOR ELEVATIONS 26 GA DUAL PITCH 24'x40' A3.01

CHECKED BY: 4012-121 DATE: 04-16-02