DSA ADMIN. REQUIREMENTS

A COPY OF PARTS 1 TO 5, TITLE 24, C.C.R. SHALL BE KEPT ON THE JOB ALL CONSTRUCTION CHANGE DIRECTIVES - C.C.D. (CHANGE ORDERS) - AND ADDENDA TO BE SIGNED BY ARCHITECT AND THE OWNER AND APPROVED BY DSA. CONSTRUCTION CHANGE DIRECTIVES - C.C.D. (CHANGE ORDERS) -AND ADDENDA ARE NOT VALID UNTIL APPROVED BY

NO CHANGES OR REVISIONS SHALL BE MADE FOLLOWING WRITTEN APPROVAL WHICH AFFECTS ACCESS COMPLIANCE ITEMS UNLESS SUCH CHANGES OR REVISIONS ARE SUBMITTED TO THE DSA FOR APPROVAL. SUBSTITUTIONS AFFECTING DSA REGULATED ITEMS SHALL BE SUBMITTED AS A CONSTRUCTION CHANGE DOCUMENT OR ADDENDA, AND SHALL BE APPROVED BY DSA PRIOR TO FABRICATION AND INSTALLATION. CONSTRUCTION CHANGE DOCUMENTS MUST BE SIGNED BY THE

FOLLOWINGS: · ARCHITECT OR ENGINEER OF RECORD.

DSA PER SECTION 4-338, PART 1, TITLE 24.

· STRUCTURAL ENGINEER (WHEN APPLICABLE) · DELEGATED PROFESSIONAL ENGINEER.

MATERIALS AND THEIR INSTALLATION SHALL COMPLY WITH APPLICABLE CODES, STANDARDS AND MANUFACTURER'S RECOMMENDATIONS. PER CBC 11B-104.1 "ALL DIMENSIONS ARE SUBJECT TO CONVENTIONAL INDUSTRY TOLERANCES EXCEPT WHERE THE REQUIREMENT IS STATED AS A RANGE WITH SPECIFIC MINIMUM AND MAXIMUM END POINTS." ALL TESTS TO CONFORM TO THE REQUIREMENTS OF SECTION 4-335, PART 1, TITLE 24, AND APPROVED TESTS AND INSPECTIONS SHEET. TESTS OF MATERIALS SHALL AND TESTING LABORATORY SHALL BE IN ACCORDANCE WITH SECTION 4-335, PART 1, TITLE 24 AND THE DISTRICT SHALL EMPLOY AND PAY THE LABORATORY. COSTS OF RE-TEST SHALL

BE PER GENERAL CONDITIONS. DSA SHALL BE NOTIFIED AT THE START OF CONSTRUCTION AND PRIOR TOTHE PLACEMENT OF CONCRETE PER SECTION 4-331. PART 1.TITLE 24. INSPECTOR SHALL BE APPROVED BY DSA. INSPECTION SHALL BE IN ACCORDANCE WITH SECTION 4-333(b). THE DUTY OF THE INSPECTOR SHALL BE IN ACCORDANCE WITH SECTION 4-342, PART 1, TITLE 24.

SUPERVISION OF CONSTRUCTION BY DSA SHALL BE IN ACCORDANCE WITH SECTION 4-334, PART 1, TITLE 24. CONTRACTOR, INSPECTOR, ARCHITECT, AND ENGINEERS SHALL SUBMIT VERIFIED REPORTS (Form SSS-6) IN ACCORDANCE WITH SECTIONS 4-336

THE ARCHITECT AND THE STRUCTURAL ENGINEER SHALL PERFORM THEIR DUTIES IN ACCORDANCE WITH SECTIONS 4-333(a) AND 4-341,

PART 1, TITLE 24. THE CONTRACTOR SHALL PERFORM HIS DUTIES IN ACCORDANCE WITH SECTIONS 4-343, PART 1, TITLE 24.

THE INTENT OF THESE DRAWINGS AND SPECIFICATIONS IS THAT THE WORK OF ALTERATION, REHABILITATION OR RECONSTRUCTION IS TO BE IN ACCORDANCE WITH TITLE 24, CALIFORNIA CODE OF REGULATIONS. SHOULD ANY EXISTING CONDITIONS SUCH AS DETERIORATION OR NONCOMPLYING CONSTRUCTION BE DISCOVERED WHICH IS NOT COVERED BY THE CONTRACT DOCUMENTS WHERE IN THE FINISHED WORK WILL NOT COMPLY WITH TITLE 24. CALIFORNIA CODE OF REGULATIONS, A CONSTRUCTION CHANGE DIRECTIVES-C.C.D., OR SEPARATE SET OF PLANS AND SPECIFCATIONS, DETAILING AND

SPECIFYING THE REQUIRED WORK SHALL BE SUBMITTED TO AND

APPROVED BY DSA BEFORE PROCEEDING WITH THE WORK.

SYMBOL LEGEND

ROOM NAME __ 101 SECTION NUMBER **DETAIL NUMBER** SHEET NUMBER SHEET NUMBER

GENERAL NOTES

DOOR NUMBER

IN THE EVENT CERTAIN FEATURES OF THE CONSTRUCTION ARE NOT FULLY SHOW! ON THE CONSTRUCTION DOCUMENTS, THEN THEIR CONSTRUCTION SHALL BE OF

STORAGE OF CONSTRUCTION MATERIAL AND EFFECT OF WORK ON EXISTING OCCUPIED AREAS SHALL BE APPROVED BY THE LOCAL FIRE AUTHORITY.

CONTRACTOR SHALL BE RESPONSIBLE FOR COORDINATION OF ALL WORK PROVIDED BY OTHERS UNDER SEPARATE CONTRACT.

KEYNOTES USED ON THE ARCHITECTURAL DRAWINGS ARE FOR ASSEMBLIES, MATERIAL REFERENCES AND NOTES. REFER TO THE KEYNOTE LIST ON THE RESPECTIVE DRAWING FOR THE INFORMATION WHICH RELATES TO EACH KEYNOTE.

DURING CONSTRUCTION, COMPLIANCE WITH CFC CHAPTER 14, FIRE SAFETY DURING

CONSTRUCTION AND DEMOLITION WILL BE ENFORCED.

DURING CONSTRUCTION, COMPLIANCE WITH CBC CHAPTER 33, SAFETY WILL BE

NO CHANGES OR REVISIONS SHALL BE MADE FOLLOWING WRITTEN APPROVAL

WHICH AFFECTS ACCESS COMPLIANCE ITEMS UNLESS SUCH CHANGES OR REVISIONS ARE SUBMITTED TO DSA FOR APPROVAL

SUBSTITUTIONS AFFECTING DSA REGULATIONS SHALL BE SUBMITTED AS A CONSTRUCTION CHANGE DOCUMENT OR ADDENDA AND APPROVED BY DSA PRIOR

SCOPE OF WORK

THE FOLLOWING IS A BRIEF DESCRIPTION OF THE SCOPE OF WORK AS REQUIRED BY DSA. CONTRACTOR SHALL DETERMINE/VERIFY THE ENTIRE SCOPE AS SHOWN IN THE DRAWINGS AND SPECIFICATIONS PRIOR TO SUBMITTING BIDS.

PLACEMENT OF TWO (2) 24'-0" X 40'-0" CLASSROOM RELOCATABLE BUILDINGS ONTO AN

STATEMENT OF GENERAL CONFORMANCE

FOR ARCHITECTS/ENGINEERS WHO UTILIZE PLANS, INCLUDING BUT NOT LIMITED TO SHOP DRAWINGS, PREPARED BY OTHER LICENSED DESIGN PROFESSIONALS AND/OR CONSULTANTS. (Application No. 03-117283 File No. 15-6)


X The MODTECH drawings or sheets listed on the cover or index sheet ☐ This drawing, page or specifications/calculations

have been prepared by other design professionals or consultants who are licensed and/or authorized to prepare such drawings in this state. It has been examined by me for:


1) design intent and appears to meet the appropriate requirements of Title 24, California Code of Regulations and the project specifications prepared by me, 2) and coordination with my plans and specifications and is acceptable for

incorporation into the construction of this project. The Statement of General Conformance "shall not be construed as relieving me of my rights, duties, and responsibilities under Sections 17302 and 81138 of the Education Code and Sections 4-336, 4-341, and 4-344" of Title 24, Part 1. (Title 24, Part 1, Section 4-317 (b))

I find that: XI All MODTECH drawings or sheets listed on the cover or index sheet ☐ This drawings or page is/are in general conformance with the project

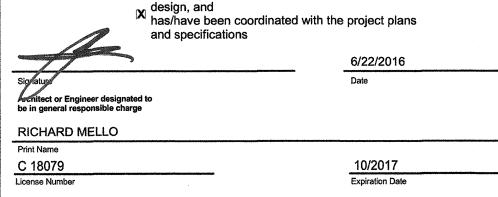

BAKERSFIELD CITY SCHOOL DISTRICT

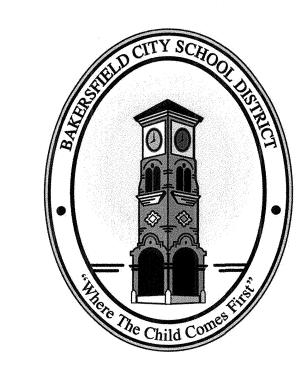

CHIPMAN JR. HIGH RELOCATABLES R-6 & R-7

2905 EISSLER ST BAKERSFIELD, CA 93306 CONSTRUCTION DOCUMENTS

DSA FILE NO.:15-6

DSA APP NO.:

AGENCY TRACKING NO.: 63321-212

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CIVIL

A0.01 TITLE SHEET

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FLOOR FRAMING PLAN **ROOF FRAMING PLAN** S2.01 STRUCTURAL FRAMING S3.01 WALL FRAMING WALL FRAMING DETAILS HVAC PLAN

ELECTRICAL PLAN RAMP/LANDING PLAN

CLASSROOM RELOCATABLE R-7 ROOM R480 MODTECH (A#04-101555) SN; 38902-38903

COVER SHEET FLOOR PLAN 24X40 **ROOF PLAN** A2.0A **EXTERIOR ELEVATIONS** INTERIOR ELEVATIONS DOOR, WINDOW, FINISH, HARDWARE SCHEDULES ARCHITECTURAL DETAILS ARCHITECTURAL DETAILS REFLECTED CEILING PLAN

REFLECTED CEILING PLAN DETAILS **FOUNDATION PLAN FOUNDATION DETAILS** FLOOR FRAMING PLAN FLOOR FRAMING DETAILS

ROOF FRAMING PLAN **ROOF FRAMING DETAILS** S2.1 STRUCTURAL ELEVATIONS AND DETAILS WALL FRAMING FRAMING DETAILS FRAMING DETAILS

HVAC PLAN E1.0 **ELECTRICAL PLAN**

RAMP / LANDING PLAN RAMP / STAIRS DETAILS

BAKERSFIELD, CA 93306

APPLICABLE CODES

CALIFORNIA CODE OF REGULATIONS, TITLE 24 - BUILDING STANDARDS

CALIFORNIA ADMINISTRATIVE CODE (CAC) (Title 24, Part 1, CCR) At Chaper 10, 2010 California Building Standards Administrative Code (Title 24, Part 1) applies CALIFORNIA BUILDING CODE (CBC), Volumes 1 & 2 (Title 24, Part 2CR)

(2012 International Building Code with 2013 California CALIFORNIA ELECTRICAL CODE, Title 24, Part 3, CCR) (2011 National Electrical Code with 2013 California amendments) CALIFORNIA MECHANICAL CODE (CMC), Title 24, Part 4, CCR)

2012 Uniform Mechanical Code with 2013 California amendments CALIFORNIA PLUMBING CODE (CPC), Title 24, Part 5, CCR) (2012 Uniform Plumbing Code with California amendments CALIFORNIA ENERGY CODE, (Title 24, Part 6, CCR) CALIFORNIA HISTORICAL BUILDING CODE, (Title 24, Part 8, CCR) CALIFORNIA FIRE CODE (CFC), Title 24, Part 9, CCR)

2012 International Fire Code with California amendments) CALIFORNIA EXISTING BUILDING CODE, (Title 24, Part 10, CCR) CALIFORNIA GREEN BUILDING STANDARDS CODE (CALGREEN), - 2010 California Green Building Standards Code applies at those portions designated by California Building Standards Commision.

CALIFORNIA REFERENCE STANDARDS CODE. (Title 24, Part 12.

ADA STANDARDS FOR ACCESSIBILITY DESIGN, U.S. Department of Justice NFPA 13, STANDARD FOR THE INSTALLATION OF SPRINKLER

2013 NFPA 72, NATIONAL FIRE ALARM CODE AND SIGNALING CODE, 2013 Edition NOTE: SOME CODES MAY NOT APPLY IF WORK REGULATED BY SUCH CODES IS NOT WITHIN THE SCOPE OF THIS PROJECT.

PROJECT DIRECTORY ARCHITECT:

BAKERSFIELD CITY SCHOOL DISTRICT 1501 FELIZ DRIVE BAKERSFIELD, CA 93307 (661) 631-4600 (661) 861-9907

CONTACT: ROBERT VANTASSEL RANDY ROWLES

PORTER AND ASSOCIATES INC. 1200 21ST. STREET BAKERSFIELD, CA. 93301 (661) 327-0362 (661) 327-1065

CONTACT: FRED PORTER

OWNER:

IBI GROUP ARCHITECTURE PLANNING 4115 BROAD STREET, SUITE B-6 SAN LUIS OBISPO, CA 93401 (805) 546-0433 (805) 546-0504 CONTACT: RICK MELLO CARLOS CACERES

ELECTRICAL: 5500 MING AVENUE #251 BAKERSFIELD, CA 93309 PHONE: FAX:

CONTACT:

(661) 831-7851 (661) 831-7813 JOHN MALONEY

CHARGER AVE CHIPMAN JUNIOR HIGH SCHOOLL

AUBURN AVE

VICINITY MAP

PRIME CONSULTANT San Luis Obispo 4119 Broad Street, Suite 210 San Luis Obispo, CA 93401 805.546.0433 fax: 805.546.0504 Any reproduction or distribution for any purpose other than authorized to IBI Group is forbidden.

CONSULTANT

DESCRIPTION

ZO

AGENCY INFORMATION: AGENCY TRACKING NO. 63321-212

NO. DATE APPRD

FILE NO. 15-6 ACNING SS FICE

BAKERSFIELD CITY SCHOOL DISTRICT



CHIPMAN JR. HIGH RELOCATABLES R-6 & R-7

> 2905 EISSLER ST BAKERSFIELD, CA 93306

OPSC or OSHPD PROJ. NO: PROJECT NO: 16132.000 DRAWN BY: C.C CHK'D BY: ISSUE DATE: 6/22/2016 SHEET TITLE

TITLE SHEET

BENCHMARK USED

TOP OF CONCRETE ON THE SOUTHEAST CORNER OF CONCRETE LANDING AS SHOWN ON GRADING PLAN.

ELEVATION = 102.96 FEET (ASSUMED DATUM)

- . ALL CONSTRUCTION SHALL CONFORM TO THIS PLAN. THE CALIFORNIA BUILDING CODE, AND STANDARDS PERTAINING THERETO. THESE DOCUMENTS SHALL BE MADE A PART HEREOF.
- . THE CONTRACTOR IS RESPONSIBLE FOR VERIFYING DIMENSIONS, DATA AND MEASUREMENTS AT THE BUILDING SITE PRIOR TO CONSTRUCTION. DO NOT SCALE DRAWINGS. WRITTEN DIMENSIONS ON THESE DRAWINGS SHALL HAVE PRECEDENCE OVER SCALED DIMENSIONS. PORTER & ASSOCIATES, INC. MUST BE NOTIFIED OF ANY VARIATIONS FROM THE DIMENSIONS AND CONDITIONS SHOWN BY THESE DRAWINGS.
- . EXISTING UTILITY AND UNDERGROUND LINES HAVE BEEN SHOWN ON THIS PLAN ACCORDING TO AVAILABLE RECORDS. THE ENGINEER IS NOT RESPONSIBLE FOR POSSIBLE ERRORS OR OMISSIONS. THE CONTRACTOR IS RESPONSIBLE FOR VERIFICATION OF THE LOCATION AND DEPTH OF ALL UTILITIES PRIOR TO BEGINNING OF ANY WORK. UNDERGROUND SERVICE ALERT (U.S.A.: 1-800-227-2600) SHALL BE CONTACTED AT LEAST TWO WORKING DAYS PRIOR TO ANY CONSTRUCTION OR EXCAVATION.
- ANY EXISTING IMPROVEMENTS OR UTILITIES THAT ARE REMOVED, DAMAGED OR UNDERCUT BY CONTRACTOR'S OPERATIONS SHALL BE REPAIRED OR REPLACED AT THE CONTRACTOR'S EXPENSE, AS DIRECTED BY THE ENGINEER AND APPROVED BY THE GOVERNING AUTHORITY.
- 5. IF A PROBLEM OR CONFLICT SHOULD ARISE DURING THE COURSE OF THE PROJECT, IT IS THE RESPONSIBILITY OF THE OWNER OR THE CONTRACTOR TO NOTIFY THE ENGINEER IMMEDIATELY PRIOR TO ANY FURTHER WORK.
- 6. THE CONTRACTOR SHALL FURNISH ALL LABOR, MATERIALS, TOOLS, EQUIPMENT AND SUPERVISION NECESSARY FOR A COMPLETE AND FUNCTIONAL PRODUCT.
- . ALL WORK WHICH IS DEFECTIVE IN ITS CONSTRUCTION OR DEFICIENT IN ANY OF THE REQUIREMENTS OF THESE DRAWINGS AND SPECIFICATIONS SHALL BE REMEDIED, OR REMOVED AND REPLACED BY THE CONTRACTOR IN AN ACCEPTABLE MANNER. AND NO COMPENSATION WILL BE ALLOWED FOR SUCH
- 8. IN THE EVENT CONSTRUCTION STAKING BASED ON THE CONSULTANT'S PLANS, DRAWINGS OR OTHER DOCUMENTS IS ACCOMPLISHED BY ANYONE OTHER THAN THE CONSULTANT, THE OWNER OR CONTRACTOR SHALL NOTIFY THE BUILDING OFFICIAL IN WRITING AS TO THE CHANGE OF ENGINEER IN RESPONSIBLE CHARGE.
-). THE CONTRACTOR AGREES THAT HE SHALL ASSUME SOLE AND COMPLETE RESPONSIBILITY FOR JOB SITE CONDITIONS DURING THE COURSE OF CONSTRUCTION OF THIS PROJECT; INCLUDING EROSION, SEDIMENTATION & DUST CONTROL PLAN AND STORM WATER POLLUTION PREVENTION PLAN IMPLEMENTATION AND THE SAFETY OF ALL PERSONS AND PROPERTY; THAT THIS REQUIREMENT SHALL APPLY CONTINUOUSLY AND NOT BE LIMITED TO NORMAL WORKING HOURS; AND THAT THE CONTRACTOR SHALL DEFEND, INDEMNIFY AND HOLD THE OWNER AND THE ENGINEER HARMLESS FROM ANY AND ALL LIABILITY, REAL OR ALLEGED, IN CONNECTION WITH THE PERFORMANCE OF WORK ON THIS PROJECT, EXCEPTING FOR LIABILITY ARISING FROM THE SOLE NEGLIGENCE OF THE OWNER OR THE ENGINEER.
- 10. IF THE CONTRACTOR IS IN DOUBT AS TO THE MEANING OF ANY PART OF THE DRAWINGS AND SPECIFICATIONS OR FINDS DISCREPANCIES IN OR OMISSIONS FROM THE DRAWINGS, HE SHALL SUBMIT A WRITTEN REQUEST FOR AN INTERPRETATION OR A CORRECTION THEREOF, PRIOR TO FILING HIS BID PRICE FOR THE PROJECT.
- PORTER & ASSOCIATES, INC. WILL NOT BE RESPONSIBLE OR LIABLE FOR UNAUTHORIZED CHANGES TO OR USES OF THESE PLANS. ANY AND ALL CHANGES TO THESE PLANS MUST BE APPROVED IN WRITING BY PORTER & ASSOCIATES, INC.

ACCESSIBILITY NOTES

- 1. ACCESSIBILITY NOTES ARE PROVIDED FOR REFERENCE ONLY. ALL WORK SHALL BE PERFORMED IN ACCORDANCE WITH APPLICABLE SECTIONS OF THE CALIFORNIA BUILDING CODE AND ADA STANDARDS. THE CONTRACTOR SHALL OBTAIN THE LATEST EDITION THEREOF.
- 2. CURB RAMPS SHALL BE 8.33% MAXIMUM GRADE. 3. PERPENDICULAR CURB RAMP SIDE SLOPES SHALL NOT EXCEED 10% GRADIENT.
- 4. SURFACE SLOPE OF RAMPS SHALL NOT EXCEED 8.33%. 5. ACCESSIBLE ROUTE SLOPES SHALL NOT EXCEED 5%, UNLESS CONSTRUCTED
- AS A RAMP AND HANDRAILS ARE PROVIDED.
- 6. ACCESSIBLE ROUTE CROSS SLOPES SHALL NOT EXCEED 2%. 7. RAMP LANDINGS SHALL NOT EXCEED 2% MAXIMUM GRADE IN ANY DIRECTIONS.
- 8. GRATINGS LOCATED WITHIN ACCESSIBLE ROUTES SHALL HAVE MAXIMUM 1/2" OPENINGS IN THE DIRECTION OF PEDESTRIAN TRAVEL.
- 9. TRANSITIONS ALONG ACCESSIBLE ROUTES SHALL BE FLUSH WITH CHANGES IN LEVEL NO GREATER THAN ½". CHANGES IN LEVEL BETWEEN ¼" AND ½" SHALL BE BEVELED WITH A MINIMUM GRADIENT OF 1:2. CHANGES IN LEVEL BETWEEN O" AND 1/2" MAY BE VERTICAL
- 10. EXCEPT BETWEEN SIDEWALKS AND ADJACENT STREETS OR DRIVEWAYS, ABRUPT CHANGES IN LEVEL EXCEEDING 4" ALONG A PATH OF TRAVEL SHALL BE PROTECTED BY A WARNING CURB A MINIMUM OF 6" IN HEIGHT ABOVE THE WALKWAY SURFACE. A WARNING CURB IS NOT REQUIRED WHEN A GUARD OR HANDRAIL IS PROVIDED WITH A GUIDE RAIL CENTERED 2" MINIMUM AND 4" MAXIMUM ABOVE THE WALKWAY SURFACE.
- 11. ALL ACCESSIBLE DOORS SHALL HAVE LEVEL LANDINGS IN ACCORDANCE WITH
- CALIFORNIA BUILDING CODE, CURRENT EDITION. 12. ACCESSIBLE PARKING STALLS AND LOADING AISLES SHALL NOT EXCEED 2% MAXIMUM GRADE IN ANY DIRECTION.

ABBREVIATIONS

CHIDEDCEUEU BY CHEET

TYPICAL ALL DEFINITION	SHEETS UNLESS SUPERSEDED BY SHE	Έ
EX	EXISTING	
FG	FINISHED GROUND	
FS	FINISHED SURFACE	
FF	FINISHED FLOOR	
NG or OG	NATURAL/ORIGINAL GROUND	
EP C	EDGE OF ASPHALT CONCRETE PAVEME	N
AC	TOP OF ASPHALT CONCRETE PAVEMEN	
AB	AGGREGATE BASE	* '
FL	FLOWLINE	
GB	GRADE BREAK	
TOC	TOP OF CONCRETE	
CONC	CONCRETE	
TC	TOP OF CURB	
~	ON THIS SHEET	
MAX	MAXIMUM	
MIN	MINIMUM	
TYP	TYPICAL	
EL or ELEV		
SF	SQUARE FEET	
LF	LINEAR FEET	
EA	EACH	
CY	CUBIC YARDS	
&WR MH	SANITARY SEWER	
	MANHOLE	
WTR .	WTR	
REQ'D	REQUIRED	

LEGEND

DESIGN GRADE DESIGN SLOPE EXISTING GRADE **EXISTING ELEVATION** 2.0% EXISTING SLOPE

GRADING CONSTRUCTION NOTES

· · · · · · · · "PATH OF TRAVEL"


- CONSTRUCT ASPHALT CONCRETE LEVEL LANDING. 2% MAXIMUM SLOPE IN ANY DIRECTION.
- 2 EXISTING ASPHALT CONCRETE TO REMAIN, PROTECT IN PLACE.
- INSTALL RAMP PER BUILDING MANUFACTURER.
- SLOPE NEW ASPHALT CONCRETE TO MATCH EXISTING AT 5% MAXIMUM SLOPE.


GRIND 0.1' MINIMUM EXISTING AC AND OVERLAY TO DESIGN] GRADES SHOWN.

ACCESS OPENINGS.


- NOTES: 1. WARP CONCRETE TO CALIFORNIA PUBLIC ACCESSIBILITY STANDARDS TO MATCH FINISHED FLOOR AT ALL BUILDING
 - 2. ACCESSIBLE PARKING SHALL NOT EXCEED 2% MAXIMUM SLOPE IN ANY DIRECTION.
 - 3. SEE ARCHITECT'S PLANS FOR ALL DIMENSIONS NOT SHOWN. 4. ALL EXISTING FEATURES ARE HALF TONED.

CONTRACTOR SHALL COORDINATE RELOCATION OF ALL EXISTING UTILITIES WITH DISTRICT.

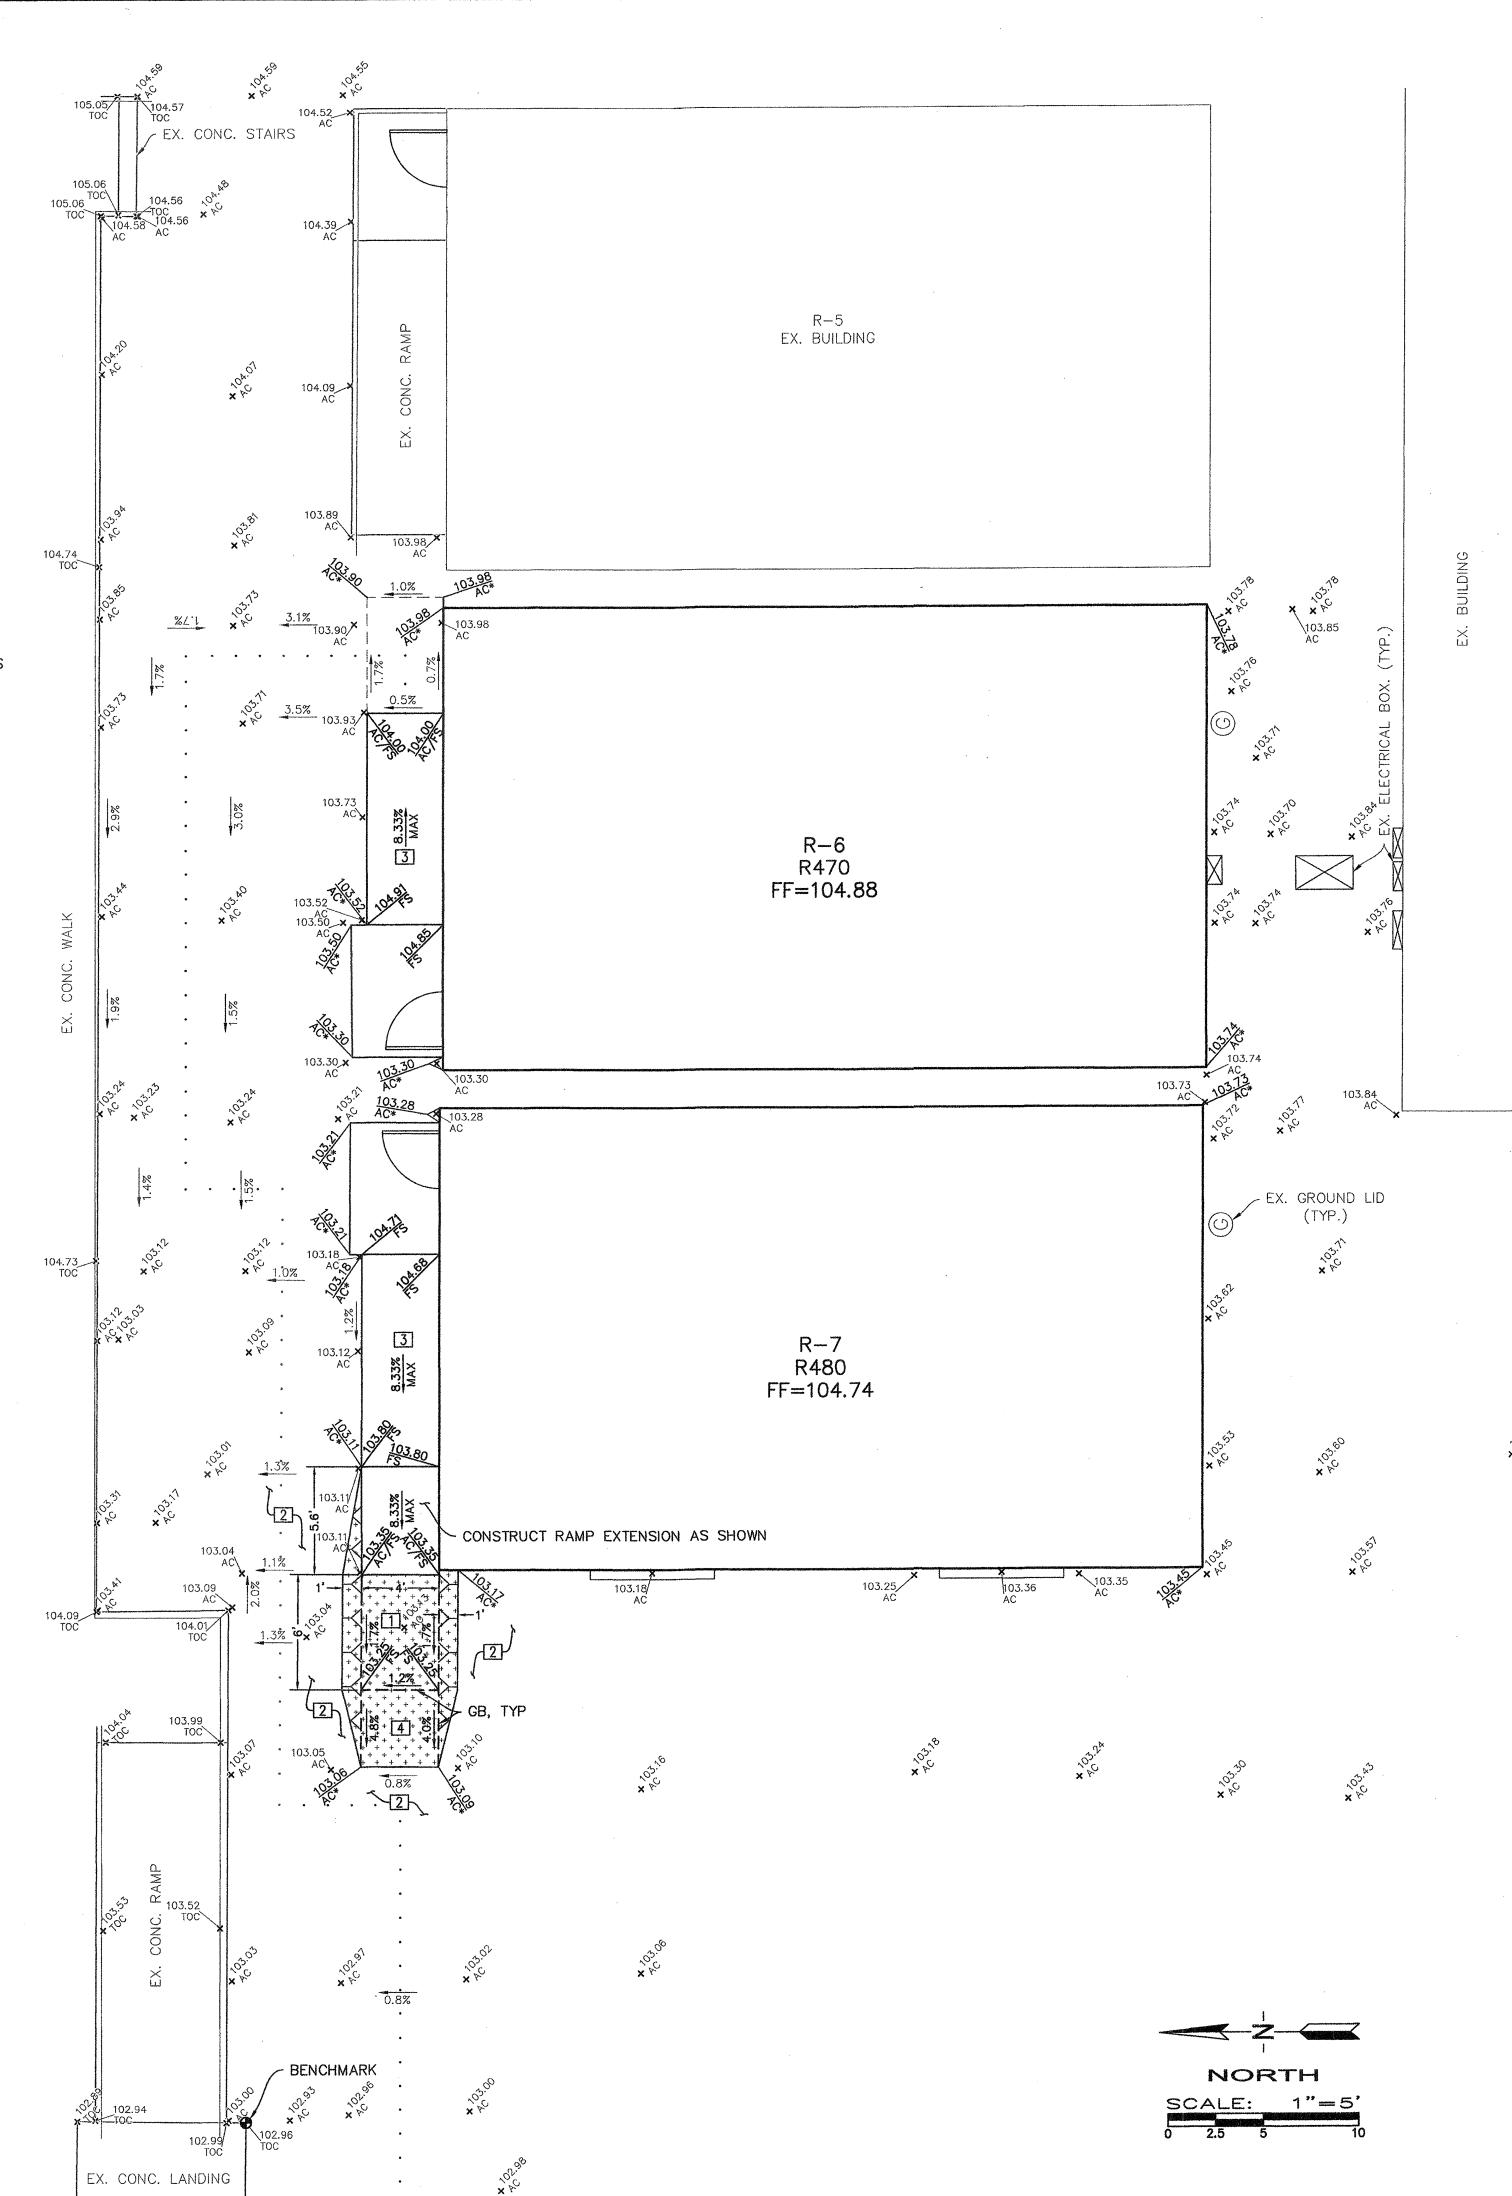

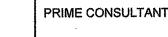

ARCHITECTURE PLANNING

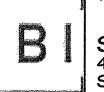

San Luis Obispo 4119 Broad Street, Suite 210 San Luis Obispo, CA 93401 805.546.0433 fax: 805.546.0504

SEAL




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CONSULTANT



ENGINEERING & SURVEYING 1200 21st Street, Bakersfield, California 93301


661.327.0362 FAX 661.327.1065

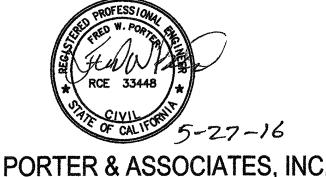AGENCY INFORMATION:

AGENCY TRACKING NO.63321-212 FILE NO. 15-6

IDENTIFICATION STAMP DIV. OF THE STATE ARCHITECT OFFICE OF REGULATION SERVICES 03-117283

BAKERSFIELD CITY SCHOOL

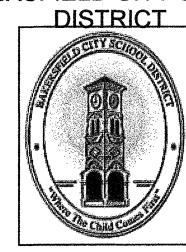


CHIPMAN JR. HIGH **RELOCATABLES R-6 & R-7**

> 2905 EISSLER ST BAKERSFIELD, CA 93306

OPSC or OSHPD PROJ. NO: PROJECT NO: 16132.000 DRAWN BY: TNB CHK'D BY: Checker ISSUE DATE: 6/22/2016 SHEET TITLE

CIVIL IMPROVEMENTS GRADING PLAN

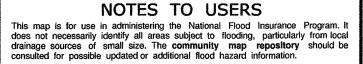

(BFEs) and/or floodways have been determined, users are encouraged to consult the Flood Profiles and Floodway Data and/or Summary of Stillwater Elevations tables contained within the Flood Insurance Study (FIS) report that accompanies this FIRM. Users should be aware that BFEs shown on the FIRM represent rounded whole-foot elevations. These BFEs are intended for flood insurance rating purposes only and should not be used as the sole source of flood elevation information. Accordingly, flood elevation data presented in the FIS report should be utilized in conjunction with the FIRM for purposes of

Coastal Base Flood Elevations shown on this map apply only landward of 0.0' North American Vertical Datum of 1988 (NAVD 88). Users of this FIRM should be aware that coastal flood elevations are also provided in the Summary of Stillwater Elevations table in the Flood Insurance Study report for this jurisdiction. Elevations shown in the Summary of Stillwater Elevations table should be used for construction and/or floodplain management purposes when they are higher than the elevations shown on this FIRM.

Boundaries of the **floodways** were computed at cross sections and interpolated between cross sections. The floodways were based on hydraulic considerations with regard to requirements of the National Flood Insurance Program. Floodway widths and other pertinent floodway data are provided in the Flood Insurance Study report for this jurisdiction.

Certain areas not in Special Flood Hazard Areas may be protected by **flood** control structures. Refer to Section 2.4 "Flood Protection Measures" of the Flood Insurance Study report for information on flood control structures for this jurisdiction.

The **projection** used in the preparation of this map was Universal Transverse Mercator (UTM) zone 11. The **horizontal datum** was NAD83, GRS1980 spheroid. Differences in datum, spheroid, projection or UTM zones used in the production of FIRMs for adjacent jurisdictions may result in slight positional differences in map features across jurisdiction boundaries. These differences do not affect the accuracy of this FIRM.

Flood elevations on this map are referenced to the North American Vertical Datum of 1988. These flood elevations must be compared to structure and ground elevations referenced to the same vertical datum. For information regarding conversion between the National Geodetic Vertical Datum of 1929 and the North American Vertical Datum of 1988, visit the National Geodetic Survey website at http://www.ngs.noaa.gov/ or contact the National Geodetic Survey at the following address:

NGS Information Services NOAA, N/NGS12 National Geodetic Survey SSMC-3, #9202 1315 East-West Highway

To obtain current elevation, description, and/or location information for **bench marks** shown on this map, please contact the Information Services Branch of the National Geodetic Survey at (301) 713–3242, or visit its website at http://www.ngs.noaa.gov/.


Base map information shown on this FIRM was derived from USDA -Farm Service Agency – Aerial Photography Field Office dated 2005 and from U.S. Geological Survey Digital Orthophoto Quadrangles produced at a scale of 1:12,000 from


This map reflects more detailed and up-to-date stream channel configurations than those shown on the previous FIRM for this jurisdiction. The floodplains and floodways that were transferred from the previous FIRM may have been adjusted to conform to these new stream channel configurations. As a result, the Flood Profiles and Floodway Data tables in the Flood Insurance Study report (which contains authoritative hydraulic data) may reflect stream channel distances that differ from what is shown on this map.

Corporate limits shown on this map are based on the best data available at the time of publication. Because changes due to annexations or de-annexations may have occurred after this map was published, map users should contact

Please refer to the separately printed **Map Index** for an overview map of the county showing the layout of map panels; community map repository addresses; and a Listing of Communities table containing National Flood Insurance Program dates for each community as well as a listing of the panels on which each

Contact the **FEMA Map Service Center** at 1–800–358–9616 for information on available products associated with this FIRM. Available products may include previously issued Letters of Map Change, a Flood Insurance Study report, and/or digital versions of this map. The FEMA Map Service Center may also be If you have **questions about this map** or questions concerning the National Flood Insurance Program in general, please call **1-877-FEMA MAP**(1-877-336-2627) or visit the FEMA website at http://www.fema.gov/.

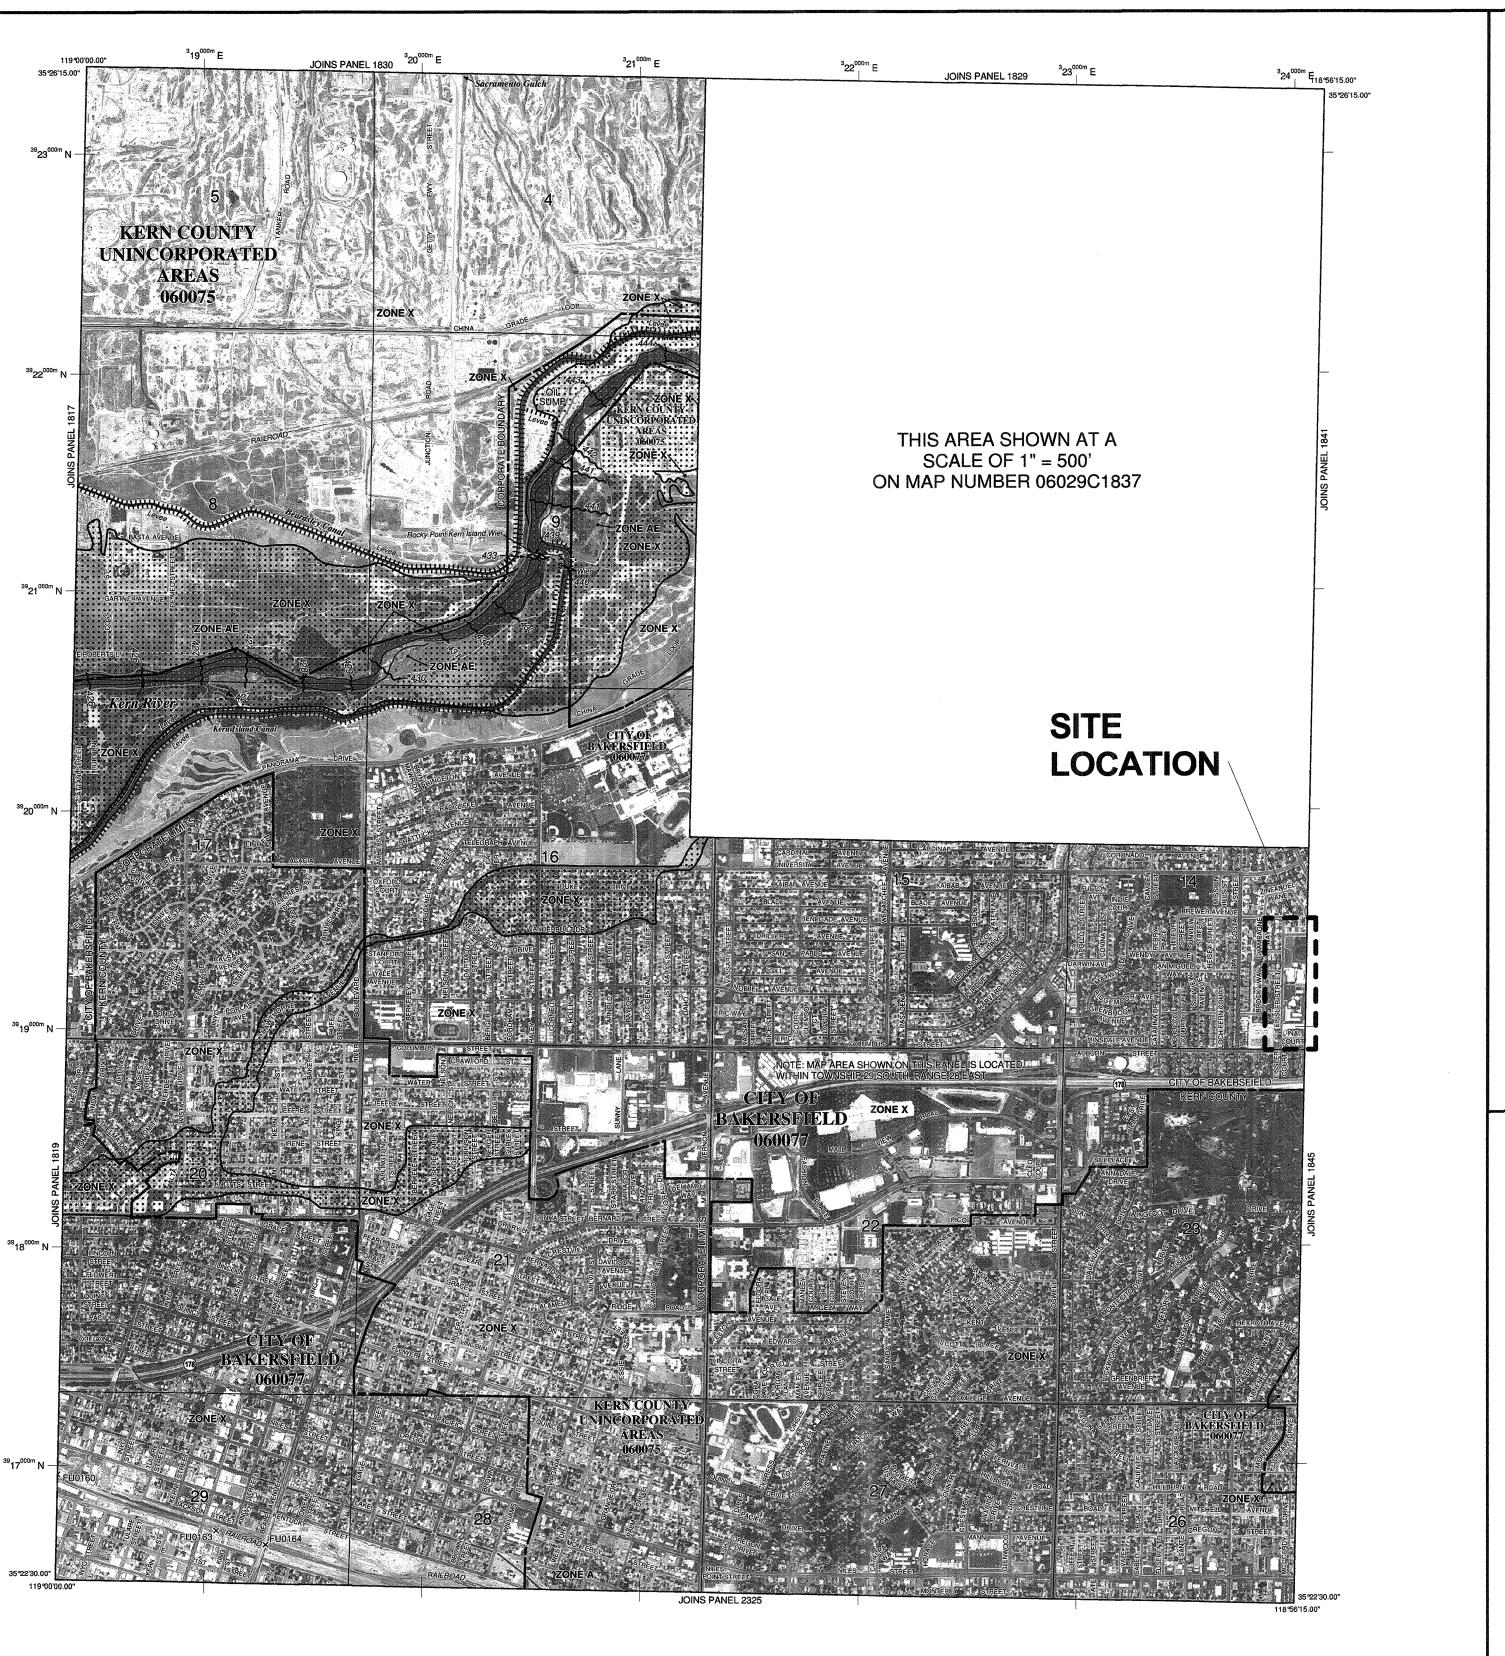

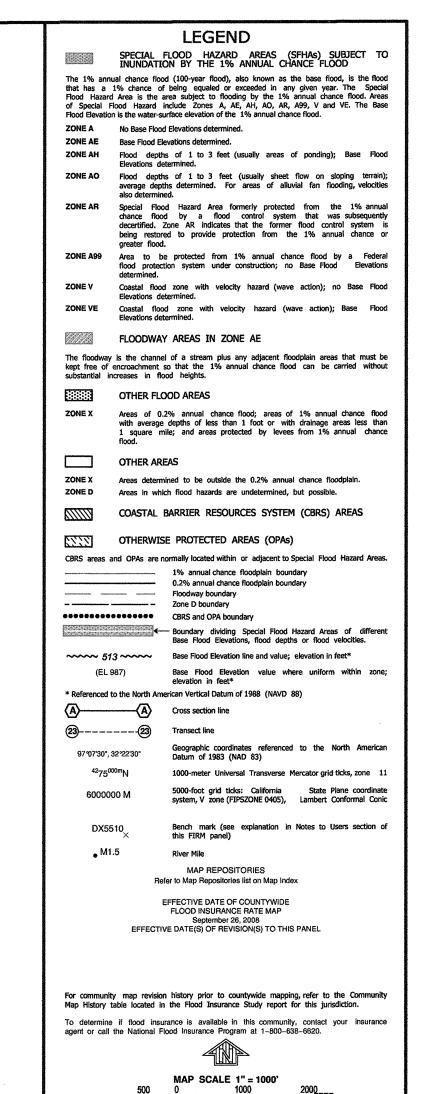

PANEL 1840E FIRM FLOOD INSURANCE RATE MAP KERN COUNTY, CALIFORNIA AND INCORPORATED AREAS PANEL 1840 OF 4125 COMMUNITY

Notice to User: The Map Number shown below should be used when placing map orders; the Community Number shown above should be used on insurance applications for the subjections. 06029C1840E **EFFECTIVE DATE**

SEPTEMBER 26, 2008 Federal Emergency Management Agency

1 FLOOD ZONE MAP AS NOTED

FLOOD ZONE MAP

SHEET NUMBER

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ARCHITECTURE PLANNING

San Luis Obispo

4119 Broad Street, Suite 210 San Luis Obispo, CA 93401

PRIME CONSULTANT

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AGENCY INFORMATION: AGENCY TRACKING NO. 63321-212 FILE NO. 15-6

> DIV. OF THE STATE ARCHITECT OFFICE OF REGULATION SERVICES 03-117283 AQVIV-FLSED SS FREE

IDENTIFICATION STAMP

BAKERSFIELD CITY SCHOOL DISTRICT



CHIPMAN JR. HIGH **RELOCATABLES R-6 & R-7**

> 2905 EISSLER ST BAKERSFIELD, CA 93306

> > 16132.000

DRAWN BY: CC. CHK'D BY: **ISSUE DATE:** 6/22/2016 SHEET TITLE

OPSC or OSHPD PROJ. NO:


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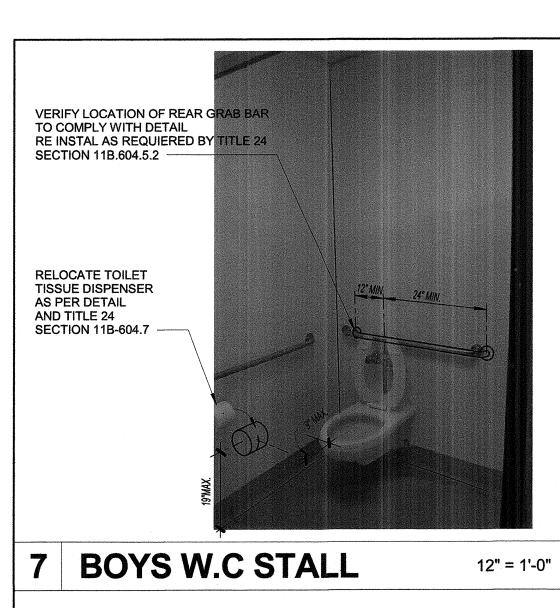
A1.10B


CONSTRUCTION DOCUMENTS

100-GENERAL NOTES

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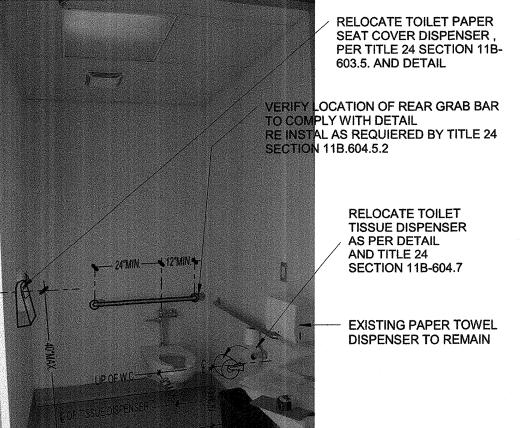


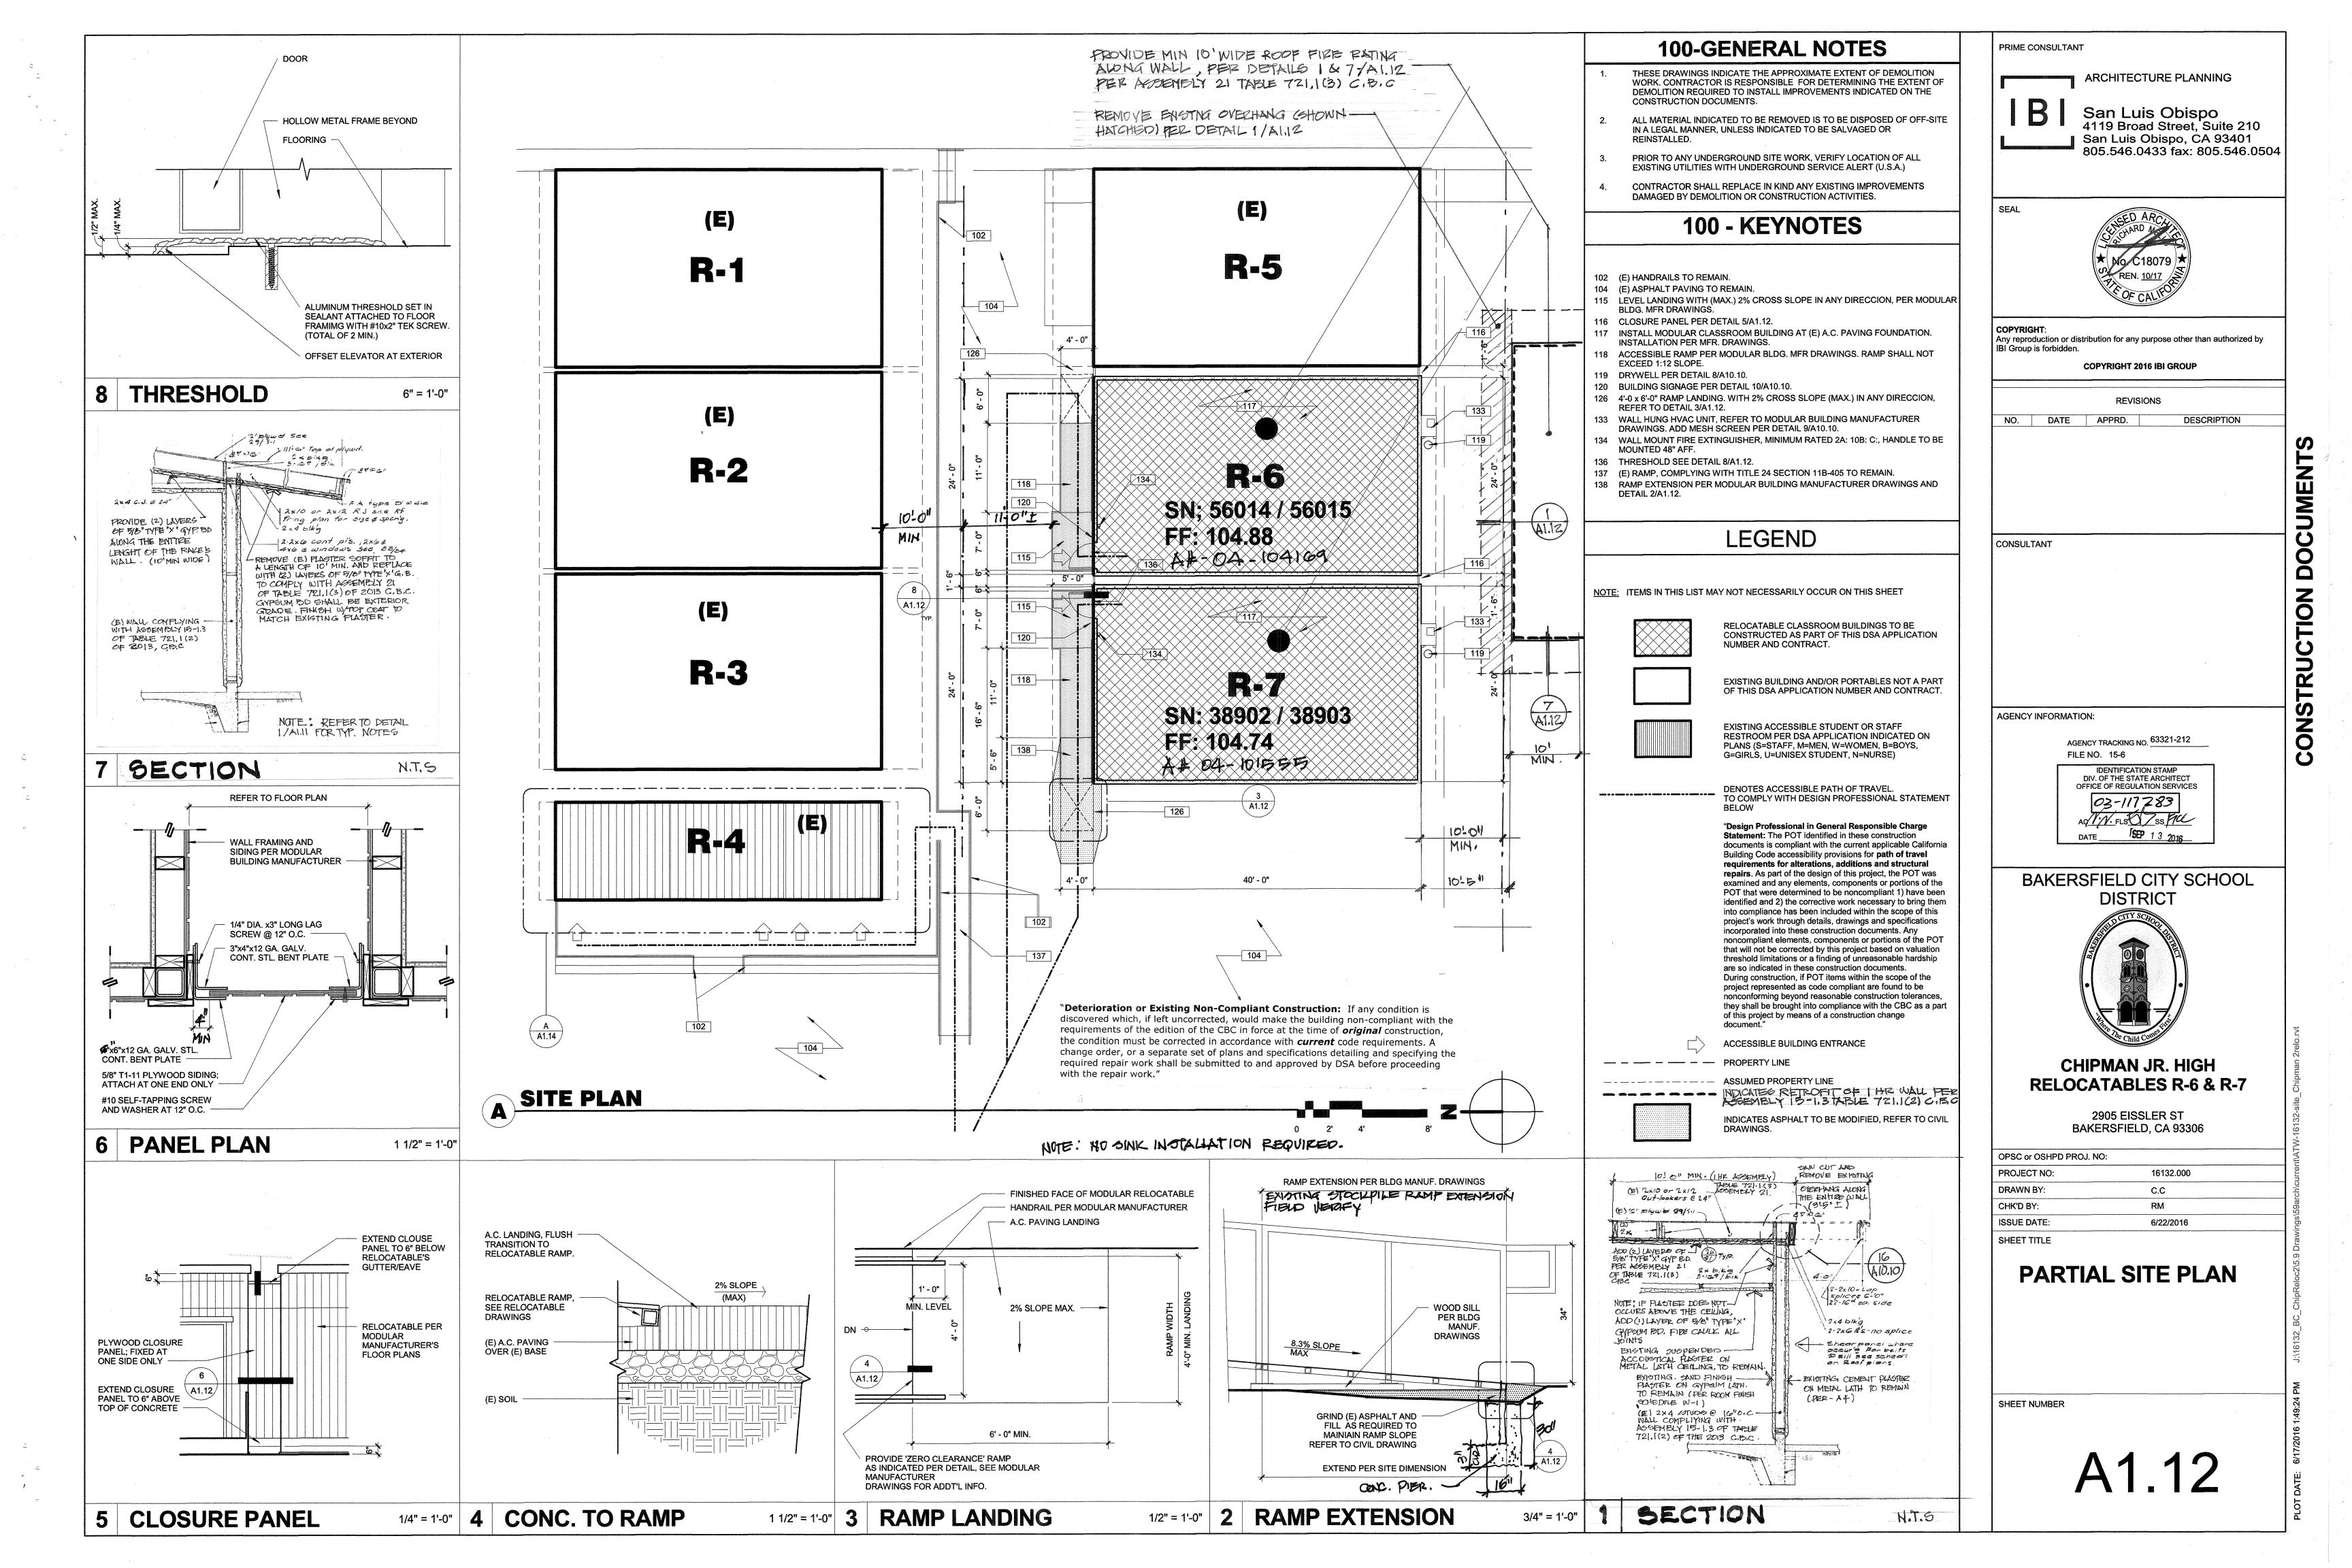



6 BOYS LAVATORY

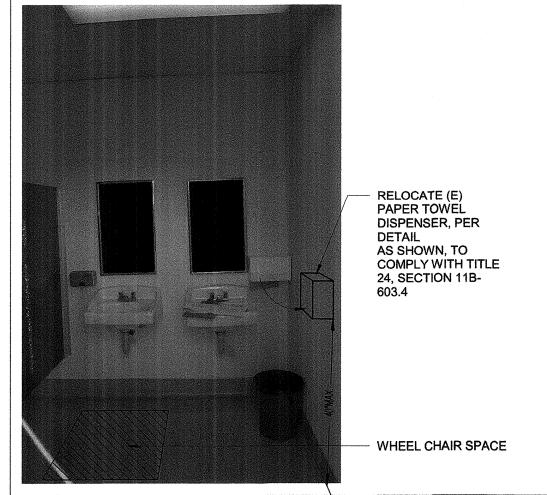12" = 1'-0"

12" = 1'-0"



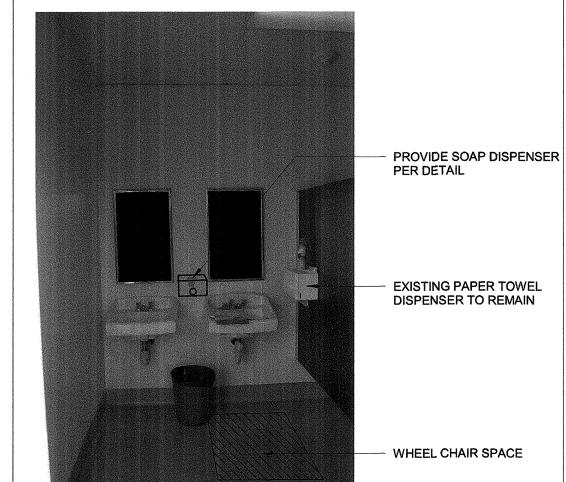

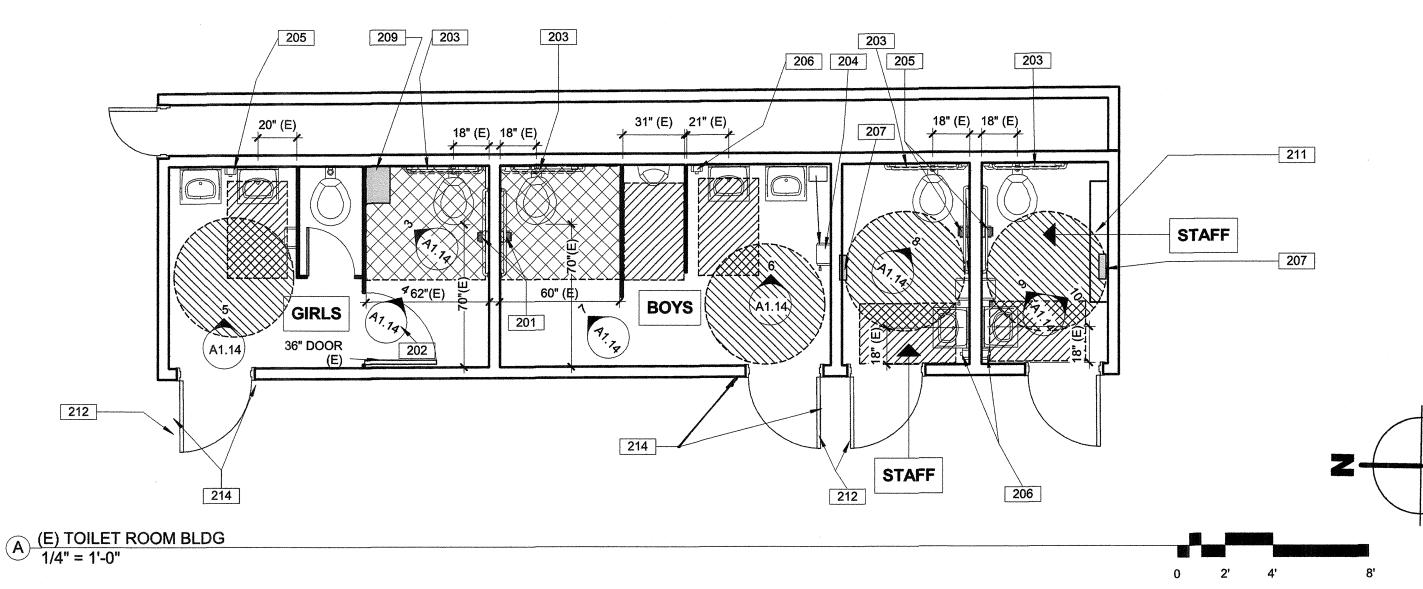

NOTES TO EXISTING RESTROOMS FLOOR PLAN:

42" MIN

- EXISTING BOY'S AND GIRL'S TOILET FIXTURES LAYOUT AND ACCESSORIES, WHERE ALTERED IN COMPLIANCE WITH THE REQUIREMENTS OF THE PRECEEDING 2010 C.B.C, TABLE 1115B-1 CHILDREN DIMENSIONS, AND OR ARE IN COMPLIANCE WITH THE 2013 C.B.C TABLE 11B-604.9, SUGGESTED CHILDREN DIMENSIONS, UNLESS OTHERWISE NOTED. REFER TO 2013 CBC CAPTER 11B-202.4 FOR EXISTING TOILET RETROFIT REQUIREMENT, EXCEPTION 2.
- EXISTING CONDITIONS AT STAFF WOMEN RESTROOM, ARE SIMILAR TO EXISTING CONDITIONS AT STAFF MEN RESTROOM THE SCOPE OF WORK ON STAFF WOMEN RESTROOM, IS EQUAL TO THE SCOPE OF WORK ON STAFF MEN RESTROOM, UNLESS OTHERWISE NOTED.

DIMENSIONS SHOWN ARE FOR TWO PIECE GRAB BAR. ONE PIECE GRAB BAR SHALL MEET THE SAME BASIC

REQUIREMENTS. SAME DIMENSIONS SHALL APPLY TO

FOUNTAIN

ALL EXISTING TOILET FIXTURES, DOORS, PARTITIONS, SIGNS, ACCESSORIES ETC. ARE TO REMAIN UNLESS OTHERWISE NOTED

SEMI-AMBULATORY STALL


VISUAL DISPLAY BOARD

2" TOILET SEAT MAX.

REFER TO DETAIL 2/A1.14 FOR ACCESSIBLE MOUNTING HEIGHTS AND DIMENSIONS.

SANITARY NAPKIN

DISPOSAL

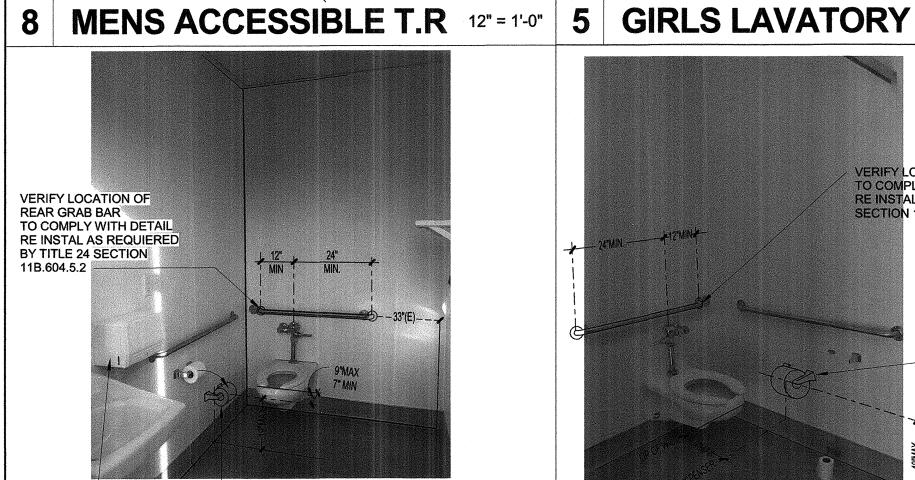

(E) PAPER TOWEL RELOCATE TOILET TISSUE DISPENSER DISPENSER TO REMAIN AS PER DETAIL AND TITLE 24 SECTION 11B-604.7

9 WOMEN ACCESS. W.C

VERIFY LOCATION OF REAR GRAB BAR TO COMPLY WITH DETAIL
RE INSTAL AS REQUIERED BY TITLE 24
SECTION 11B.604.5.2 PROVIDE TOILET TISSUE DISPENSER AS PER AND TITLE 24 SECTION 11B-604.7


ACCESSIBLE MOUNTING HEIGHTS 12" = 1'-0" **4 GIRLS W.C STALL**

EXTINGUISHER

TOILET TISSUE DISPENSER

TOILET SEAT COVER -

12 MIN 24" MIN

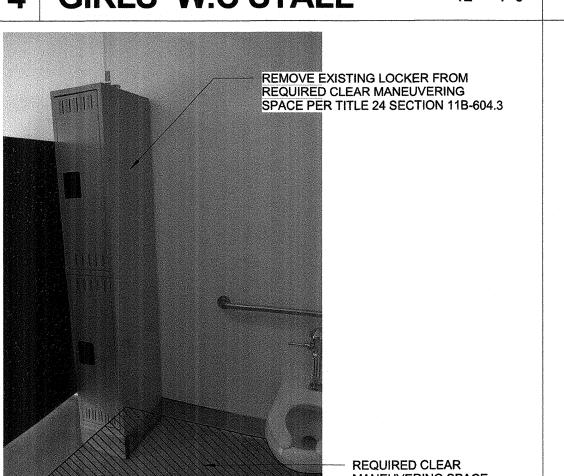

	LETTER	DESCRIPTION	ADULTS AGES 13 & OLDER	CHILDREN AGES 9-12	
	Α	WHEELCHAIR ACCESSIBLE WATER CLOSET CENTERLINE	17" - 18"	15" - 18"	
	A1	AMBULATORY ACCESSIBLE WATER CLOSET CENTERLINE	17" - 19"	15" - 18"	
	В	TOILET SEAT HEIGHT (TO TOP OF SEAT)	17" MIN - 19" MAX	15" - 17"	
,	С	GRAB BAR HEIGHT (TOP OF GRIPPING SURFACE)	33" MIN - 36" MAX	25" - 27"	
	D	TOILET TISSUE DISPENSER TO TOILET	7" - 9"	7" - 9"	
	D1	TOILET TISSUE DISPENSER (OUTLET OF DISPENSER FROM FLOOR)	19" MIN	17" - 19"	
	D2	TOILET TISSUE DISPENSER (FROM BOTTOM OF GRAB BAR)	1 1/2" MIN CLR	1 1/2" MIN CLR	
-	E	SANITARY NAPKIN DISPOSAL TO TOILET	5"	5"	
	E1	SANITARY NAPKIN DISPOSAL FROM FLOOR TO TOP	17" - 19"	15" - 18"	
	F	DISPENSER OR MIRROR TO REFLECTIVE SURFACE	40" MAX	40" MAX	
	G	LAVATORY/ SINK HEIGHT	34" MAX	34" MAX	
	G1	LAVATORY APRON CLEARANCE	29" MIN	29" MIN	
	Н	KNEE CLEARANCE	27" MIN	27" MIN	
	ı	URINAL RIM HEIGHT	17" MAX	17" MAX	
	J	URINAL FLUSH CONTROL HEIGHT	44" MAX	44" MAX	
	J1	WATER CLOSET FLUSH CONTROL HEIGHT	44" MAX	36" MAX	
	К	DRINKING FOUNTAIN SPOUT HEIGHT	36" MAX	30" MAX, SIDE APPROACH	
	L	DRINKING FOUNTAIN KNEE CLEARANCE	27" MIN	27" MIN	

FIRE EXTINGUISHER WITH QUICK RELEASE BRACKET

FIRE EXTINGUISHER CABINET, 4"

MAX. PROJECTION

200 - KEYNOTES PROVIDE "U" SHAPE HANDLE EACH SIDE OF EXISTING STALL DOOR RELOCATE EXISTING 36" REAR GRAB BAR TO COMPLY WITH TITLE 24 SECTION REMOVE AND RELOCATE EXISTING PAPER TOWEL DISPENSER TO ACCESSIBLE LOCATION SHOWN. AS PER DETAIL 2/A1.14 PROVIDE SOAP DISPENSER. MOUNT PER DETAIL 2/A1.14

TV/VCR MOUNTING

PAPER TOWEL

RECEPTACLE

DISPENSER WITH TRASH


(E) SOAP DISPENSER TO REMAIN RELOCATE SEAT COVER DISPENSER SLOT HEIGHT TO MAX 40"AFF, PER REMOVE EXISTING LOCKER, PROVIDE CLEAR MANEUVERING SPACE AS PER TITLE 24, SECTION 11B-604.3.2

LAVATORY

REMOVE EXISTING 5'-0" SHELVE AND RELOCATE, TOP OF SHELVE SHALL BE 48" A.F.F AS PER DETAIL 2/A1.14 REVISE CLOSER AT RELOCATABLE DOORS OPERATING PRESSURE TO 5 LBS

VERIFY (E) DOOR SIGNAGE COMPLIES WITH 2013 CBC CODE. RELOCATE OR PROVIDÈ SIGNAGE PER DETAIL 4/A10.10 (BUILDING R-4).
IN CUIDING RESTEOOM WALL SIGN

200 LEGEND

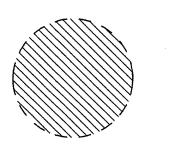

SANITARY NAPKIN

DISPENSER

4" MAXIMUM

PROJECTION

DISPENSER

COAT HOOK

INDICATES CLEAR 60" Ø MANEUVERING SPACE

SOME FIXTURES/ACCESSORIES SHOWN

ELEVATIONS TAKE PRECEDENCE OVER

FIXTURES/ACCESSORIES SHOWN ARE

MOUNTING HEIGHTS FOR ABLE

BODIED PERSONS SHALL BE

AT HEIGHTS ACCESSIBLE TO PERSONS

DETERMINED BY RECOMMENDATIONS

FROM THE MANUFACTURER, UNLESS

WATER CLOSET FLUSH VALVE SHALL BE

ORIENTED ON THE APPROACH SIDE OF

MOUNT GRAB BARS 36" ABOVE FINISHED FLOOR AT TANK TYPE TOILETS. ALLOW

1/4" = 1'-0"

FOR DIMENSIONS INDICATED BY A LETTER REFER TO DETAIL 2

MAY NOT APPLY TO THIS PROJECT.

HEIGHTS INDICATED ON INTERIOR


HEIGHTS SHOWN HERE.

WITH DISABILITIES.


NOTED OTHERWISE.

ACCESSIBLE TOILET.

6" CLR TO GRAB BAR.

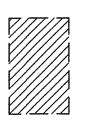


INDICATES CLEAR 30"X48" WHEELCHAIR SPACE

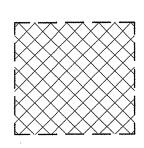

INDICATES CLEAR 60"X56" MANEUVERING SPACE AT WALL HUNG WATER CLOSETS.



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REVISIONS

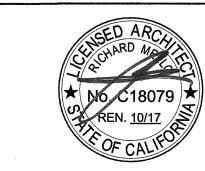DESCRIPTION

NO. DATE APPRD.

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DIV. OF THE STATE ARCHITECT OFFICE OF REGULATION SERVICES 03-117283 AC// FL8 SS FACE DATE | SEP 1 3 2016

BAKERSFIELD CITY SCHOOL DISTRICT



CHIPMAN JR. HIGH RELOCATABLES R-6 & R-7

2905 EISSLER ST


BAKERSFIELD, CA 93306

OPSC or OSHPD PROJ. NO: PROJECT NO: 16132.000 DRAWN BY: CC CHK'D BY: RM ISSUE DATE:

> **EXISTING RESTROOM**

SHEET NUMBER

SHEET TITLE

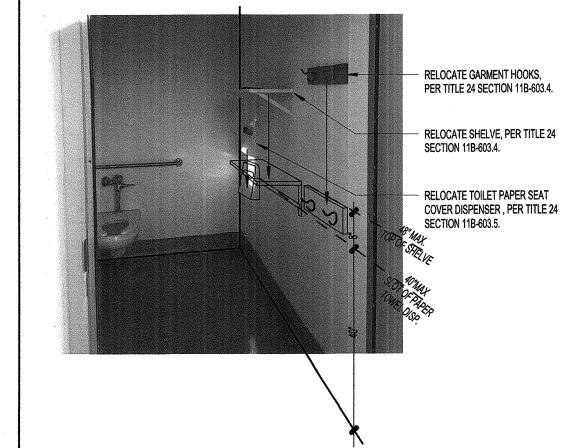


10 WOMEN ACCESS T.R

MANEUVERING SPACE

3 GIRLS W.C STALL

2 MOUNTING HEIGHTS 12" = 1'-0"

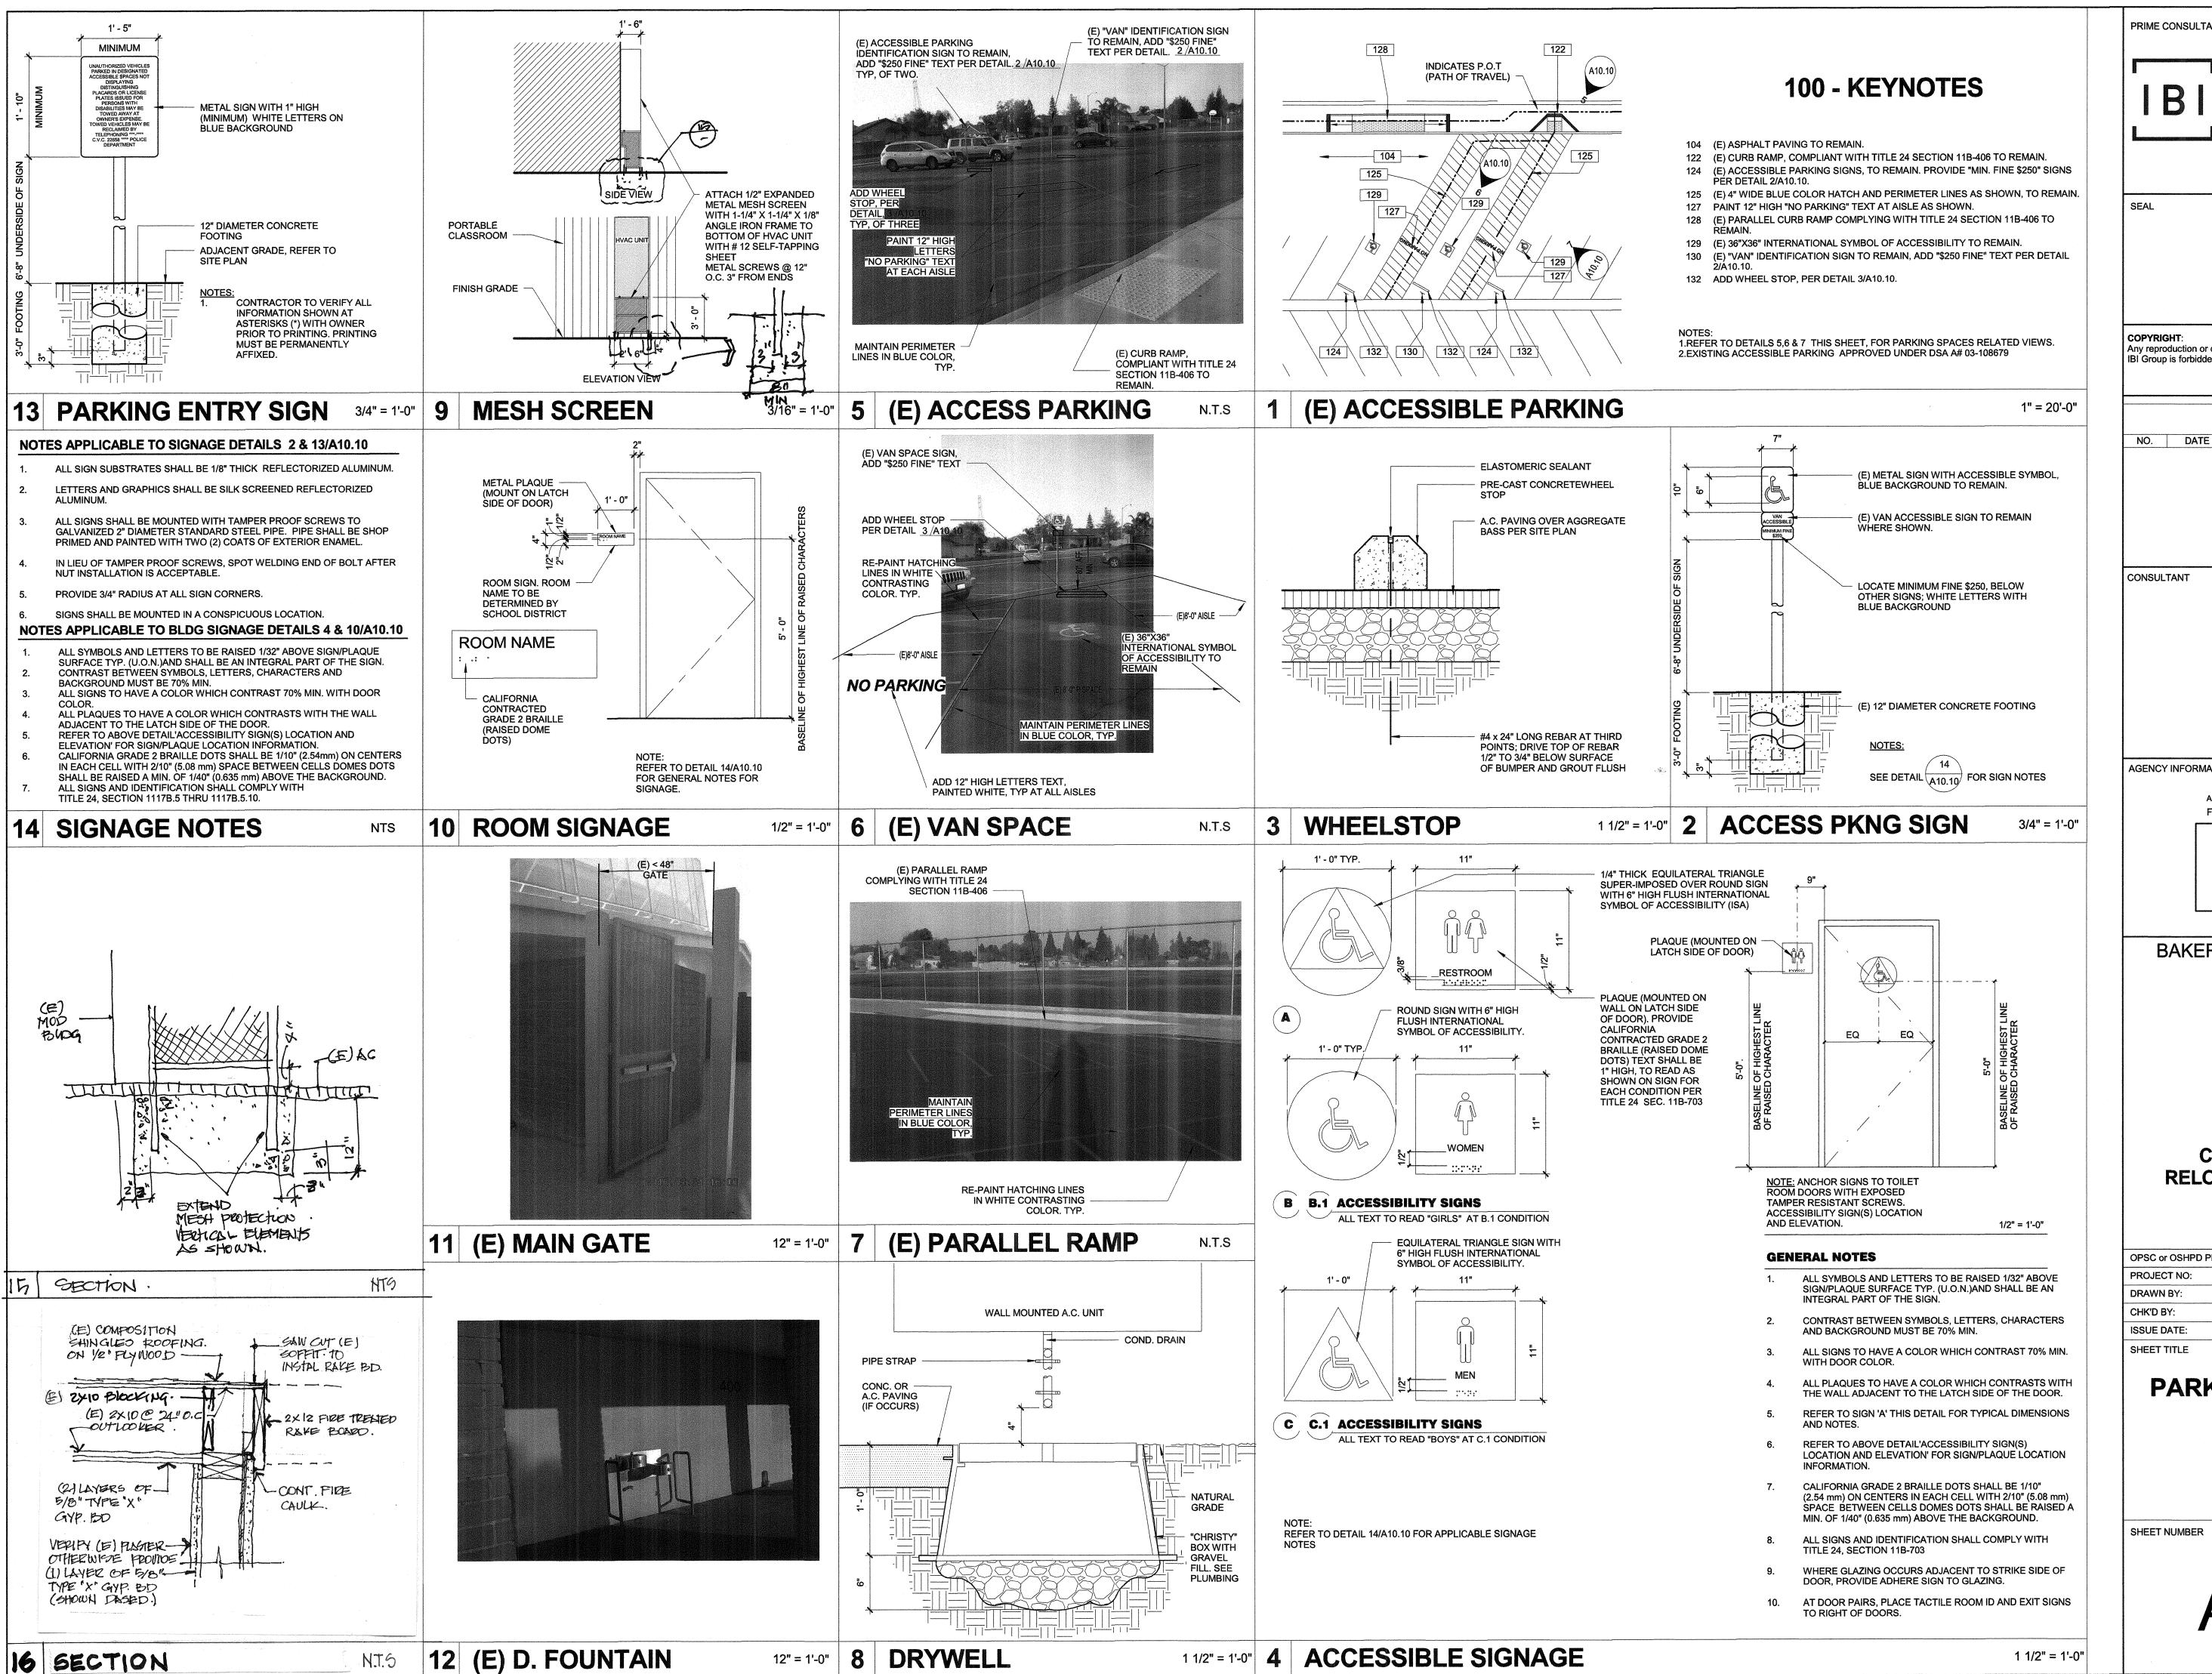

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BAKERSFIELD CITY SCHOOL DISTRICT



CHIPMAN JR. HIGH RELOCATABLES R-6 & R-7

> 2905 EISSLER ST BAKERSFIELD, CA 93306

OPSC or OSHPD PROJ. NO: 16132.000 C.C 6/22/2016

> PARKING & ACCESS **DETAILS**

A10.10

EXISTING ELECTRICAL SERVICES HAS BEEN

SHOWN ON THESE PLANS SITE INSPECTOR IS TO WITNESS AND VERIFY


GROUNDING TESTS

INVESTIGATED AND FOUND TO HAVE ADEQUATE CAPACITY FOR THE PROPOSED LOAD ADDITION



GENERAL NOTES

- VISIT JOB SITE AND VERIFY EXISTING CONDITIONS PRIOR TO BID.
- THE ELECTRICAL WORK SHALL BE INSTALLED IN ACCORDANCE WITH THE CALIFORNIA ELECTRICAL CODE AND ALL APPLICABLE LOCAL ORDINANCES. WHERE PLANS CALL FOR A HIGHER STANDARD THAN APPLICABLE CODES, THE PLANS SHALL GOVERN.
- CONDUIT RUNS ARE SHOWN DIAGRAMMATICALLY. EXACT LOCATIONS SHALL BE DETERMINED IN THE FIELD TO SUIT FIELD CONDITIONS.
- ALL ELECTRICAL EQUIPMENT, APPLIANCES AND LIGHTING FIXTURES SHALL BE LISTED BY A RECOGNIZED TEST LAB AND BEAR THAT LABEL OF APPROVAL.
- CONTRACTOR SHALL FURNISH, INSTALL AND CONNECT ALL MATERIAL AND EQUIPMENT FOR THIS WORK UNLESS OTHERWISE NOTED.
- FURNISH DISCONNECT SWITCHES AT REMOTE MOTORS.
- ALL SPACES AS INDICATED ON PANELS OR SWITCHBOARD SHALL BE COMPLETE WITH HARDWARE AND BUSSING FOR FUTURE BREAKER OR SWITCH.
- CHECK ARCHITECTURAL PLANS FOR DOOR SWINGS BEFORE INSTALLING SWITCH OUTLETS.
- GROUNDING AND BONDING SHALL BE PER CODE PLUS ANY ADDITIONAL PROVISIONS SPECIFIED OR SHOWN ON DRAWINGS.
- 10. ALL CONDUIT RUNS SHALL CONTAIN A CODE SIZED GROUND CONDUCTOR.
- 11. THESE PLANS ARE NOT COMPLETE UNTIL APPROVED BY THE AUTHORITY HAVING URISDICTION.
- 12. ALL CONDUCTORS SHALL BE IN CONDUIT.
- 13. ALL CONDUCTORS SHALL BE COPPER WITH TYPE THHN/THWN INSULATION.
- 14. CURRENT CALIFORNIA BUILDING CODE ACCESS COMPLIANT MOUNTING HEIGHTS APPLY ONLY TO NEW OR RELOCATED ELECTRICAL SWITCHES, OUTLETS, PUSH BUTTONS ETC.. THEY SHALL COMPLY WITH CALIFORNIA BUILDING CODE 1117B.6.
- 15. COORDINATE WITH SERVING ELECTRICAL UTILITY COMPANY AND MAKE PROVISIONS FOR ELECTRICAL SERVICE ACCORDINGLY. INCLUDE ALL SERVICE COSTS AND UTILITY COMPANY CHARGES IN BID.
- COORDINATE WITH SERVING TELEPHONE UTILITY COMPANY AND MAKE PROVISIONS FOR TELEPHONE SERVICE ACCORDINGLY. INCLUDE ALL SERVICE COSTS AND ANY UTILITY COMPANY CHARGES I BID.

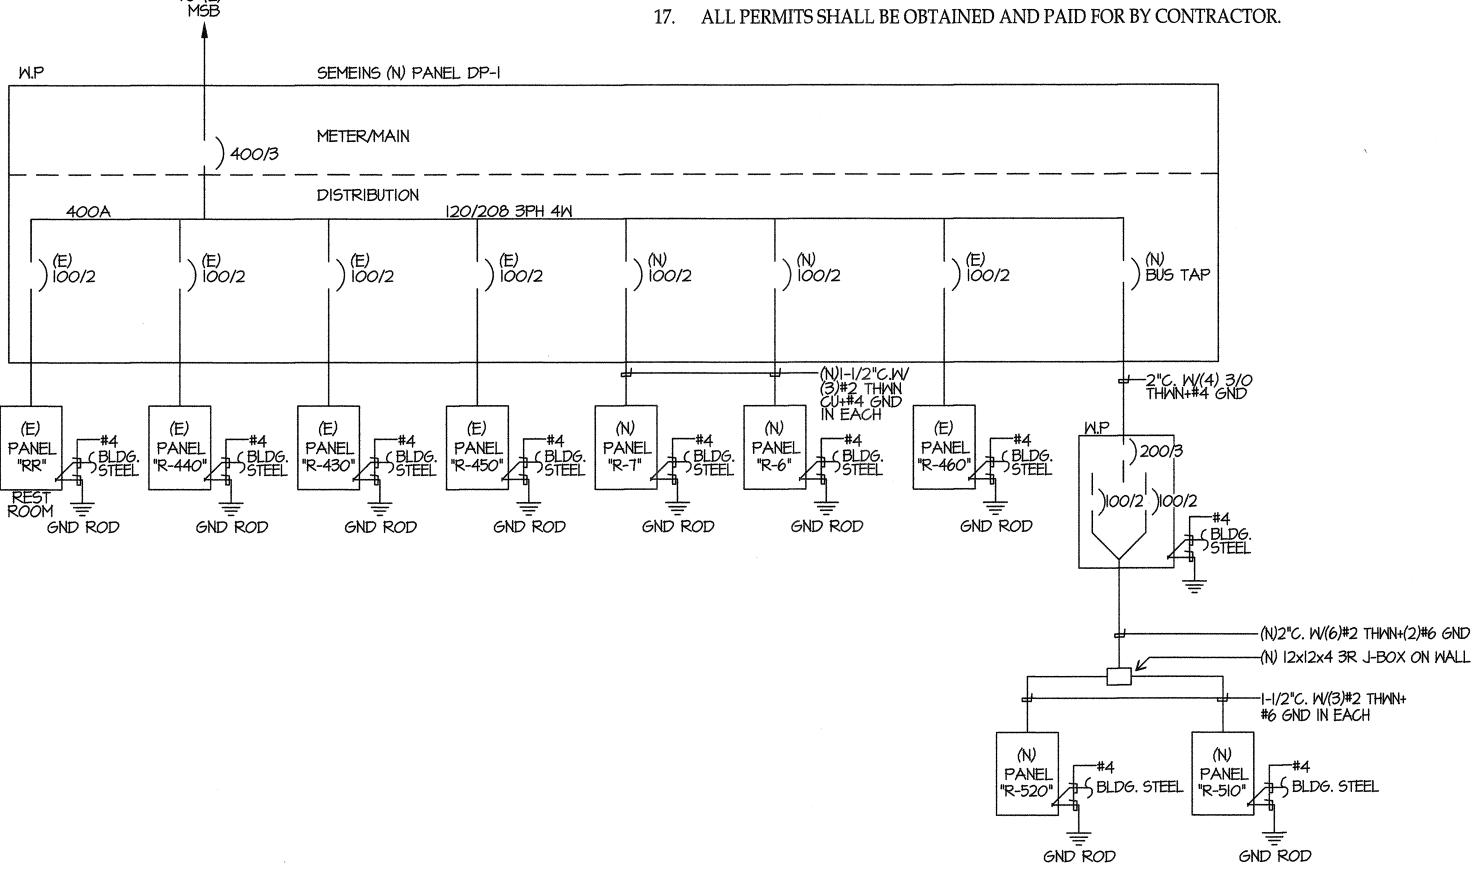

SYMBOLS CONDUIT EXISTING CONDUIT CONCEALED IN WALL OR CEILING CONDUIT CONCEALED UNDER FLOOR OR BELOW GRADE CONDUIT STUBBED OUT AND CAPPED CONDUIT TURNED UP CONDUIT TURNED DOWN HATCH MARKS INDICATE NO. OF #12 WIRES IN CODE SIZED CONDUIT IN 3/4" C., (8) MAX. IN 1"C., NO MARKS = 2#12HOME RUN: LETTER INDICATES PANEL, NUMBER(S) INDICATES GROUND CONNECTION DISTRIBUTION SWITCHBOARD OR PANEL PANEL, BRANCH CIRCUIT TYPE, SURFACE AND FLUSH SIGNAL TERMINAL CABINET, SURFACE & FLUSH CUTLET DATA: BAR INDICATES WALL MOUNT, LETTER INDICATES SWITCH CONTROL, NO. INDICATES CIRCUIT. 0 SURFACE FIXTURE ON FLUSH OUTLET. RECESSED FIXTURE WITH JUNCTION BOX FOR THRU WIRING EXIT LIGHT WITH ARROWS AS SHOWN ON PLANS, WALL AND CEILING MOUNT. EXTERIOR WALL MOUNT FIXTURE LOW LEVEL EXIT SIGN, +6" AFF, +4" FROM DOOR JAMB LIGHT FIXTURE DESIGNATION, LETTER INDICATES TYPE, NO. INDICATES WATTAGE. SEE FIXTURE SCHEDULE MECHANICAL EQUIPMENT DESIGNATION. SEE MECHANICAL DRAWINGS. SPECIAL RECEPTACLE - SEE PLAN M-} \odot FLUGH FLOOR RECEPTACLE \Rightarrow RECEPTACLE, DUPLEX, 15A, 125V, NEMA 5-15R +18" UND. DUPLEX RECEPTACLE MTD. ABOVE BACKSPLASH+42" UNO. DUPLEX RECEPTACLE W/LOWER HALF SWITCHED +18" UNO. GROUND FAULT CIRCUIT INTERRUPTING RECEPTACLE 18" UN.O. DOUBLE DUPLEX RECEPTAGLE +18" UNO. CEILING RECEPTACLE RECEPTACLE, DUPLEX, 20A, 125V, NEMA 5-20R +18" UNO. JUNCTION BOX 4" SQUARE, 1-1/2" DEEP U.N.O. THERMOSTAT F.B.O. +48" MOTOR, NO. INDICATES HORSEPOWER CLOCK OUTLET +7-6" UNO. 0 마 DISCONNECT SWITCH, NON-FUSED DISCONNECT SWITCH FUSED HORSEPOWER RATED OR SIZED AS COMBINATION MAGNETIC STARTER WITH DISCONNECT SWITCH AND MAGNETIC MOTOR STARTER W/OVERLOADS IN EACH PHASE DIMMER W/INTEGRAL "ON-OFF" SW. +48" UN.O. PUSHBUTTON +48" UNO. PHOTOCELL SMOKE DETECTOR WIRELESS ACCESS POINT TELEPHONE/COMPUTER/DATA OUTLET, TWO GANG BOX W/I GANG COVERPLATE & GROMMETED OPENING +18" U.N.O. CAPLE TV OUTLET +18" UNO. MOTION SENSOR ACCESS POINT WIRELESS CAMERA EXISTING SWITCH SINGLE POLE SWITCH QUIET TOGGLE TYPE RATED AT DOUBLE POLE SWITCH 20A 120/2TN AC. +42" UNO. THREE WAY SWITCH SWITCH W/PILOT LT. MANUAL MOTOR STARTER FIRE ALARM CONTROL PANEL

GROUND FAULT CIRCUIT INTERRUPTING LABOR SAVING TANDEM MAIN LUGS ONLY

CONDUIT ONLY WEATHERPROOF FURNISHED BY OTHERS, INSTALL & CONNECT

UNLESS NOTED OTHERWISE N.E.C. NATIONAL ELECTRICAL CODE NOT IN CONTRACT

> REMOVE RELOCATE SURFACE MOUNT

UNDERGROUND COLD WATER PIPE


ABOVE FINISHED FLOOR HEATING AND AIR CONDITIONING RATED CIRCUIT BREAKER

NOTE: NOT ALL SYMBOLS SHOWN ARE USED ON THIS PROJECT.

PRIME CONSULTANT

ARCHITECTURE PLANNING San Luis Obispo 4115 Broad Street, Suite B-6 San Luis Obispo, CA 93401 805.546.0433 fax:805.546.0504

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CONSULTANT LIGHT NG DESIGN 16136

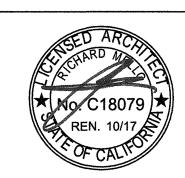5500 MING AVENUE, SUITE 251 BAKERSFIELD, CA 93309 (661) 831-7851 FAX (661) 831-7813

AGENCY INFORMATION:

AGENCY TRACKING NO. 63321-212

FILE NO. 15-6 IDENTIFICATION STAMP DIV. OF THE STATE ARCHITECT OFFICE OF REGULATION SERVICES AC FLS SS FACE DATE SEP 1 3 2016

BAKERSFIELD CITY SCHOOL



CHIPMAN JR. HIGH **RELOCATABLES R-6 & R-7**


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OPSC or OSHPD PROJ. NO: PROJECT NO: 16132.000 DRAWN BY: AC WR CHK'D BY: 06/22/2016 ISSUE DATE: SHEET TITLE

> SYMBOL LIST **GENERAL NOTES** SINGLE LINE DIAGRAM


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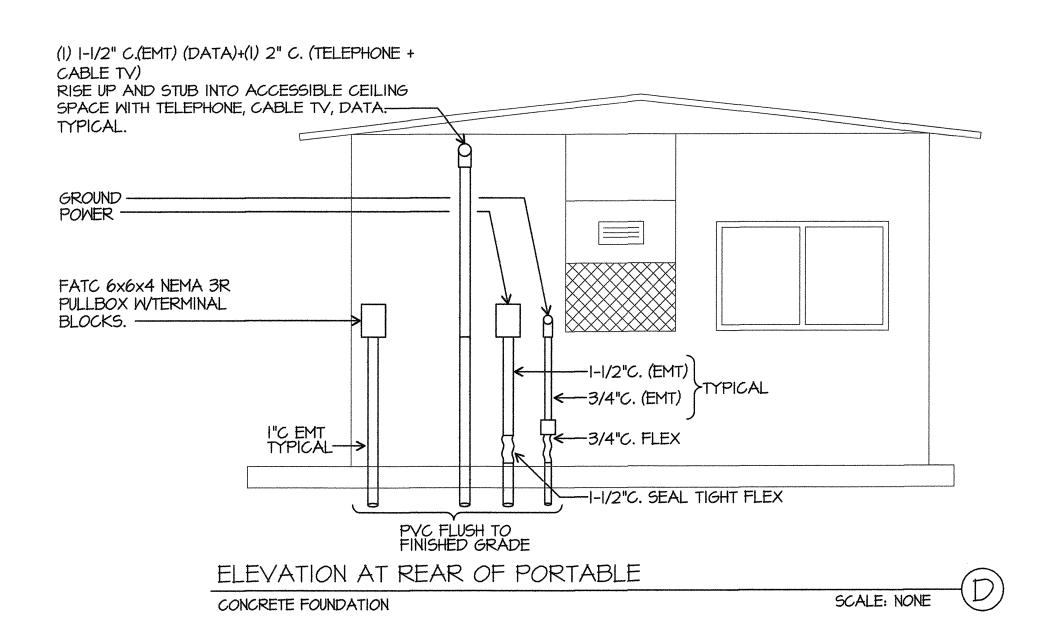
E-0




TYPICAL TRAILER STEEL FRAME BONDING/GROUNDING DETAIL

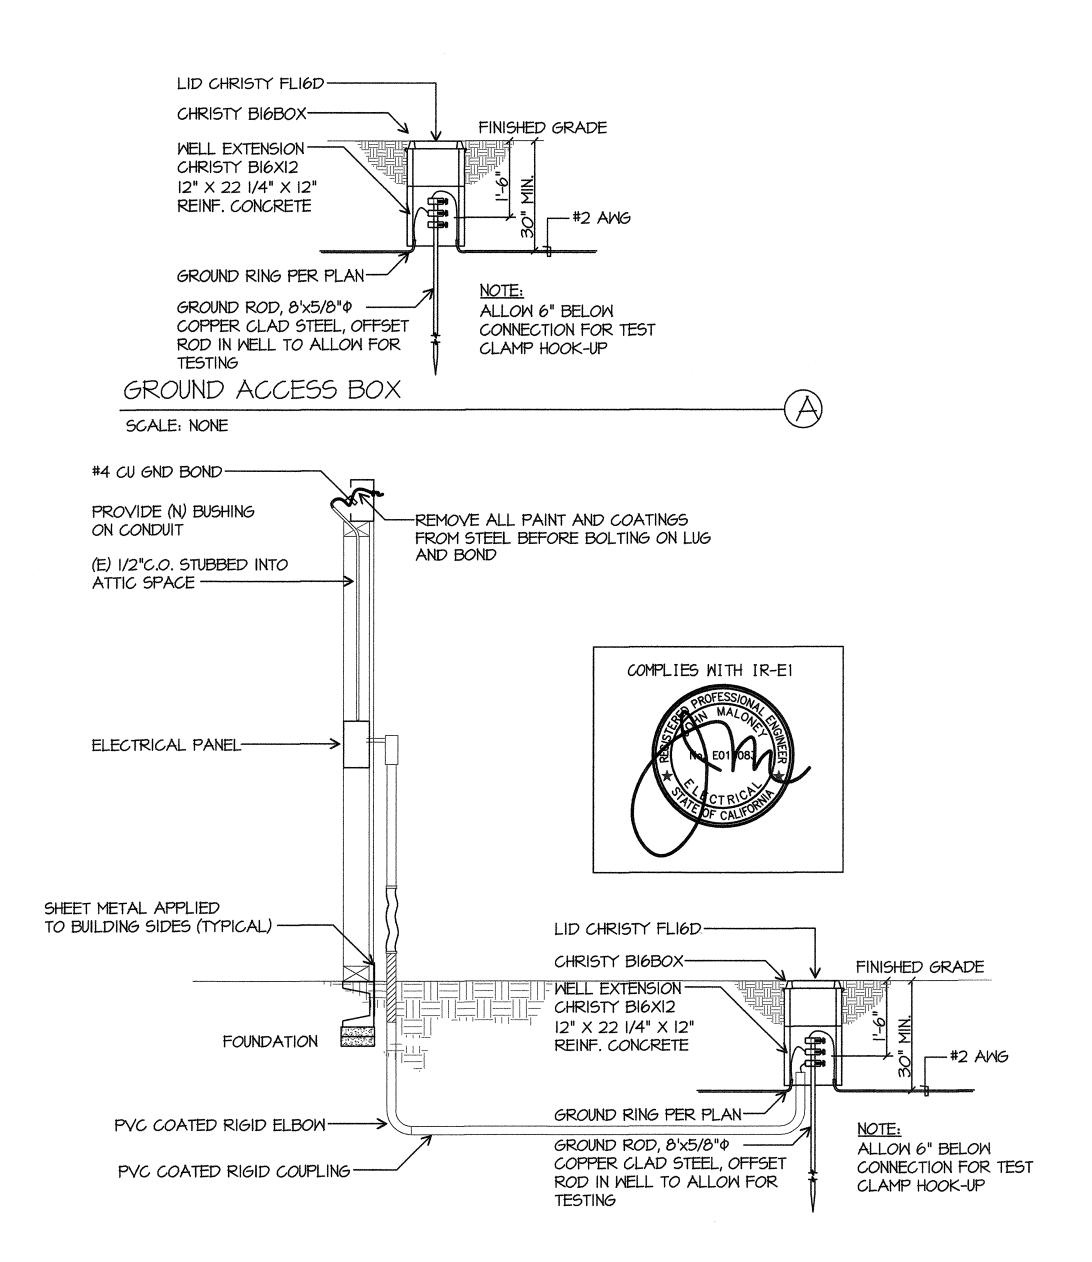SCALE: NONE



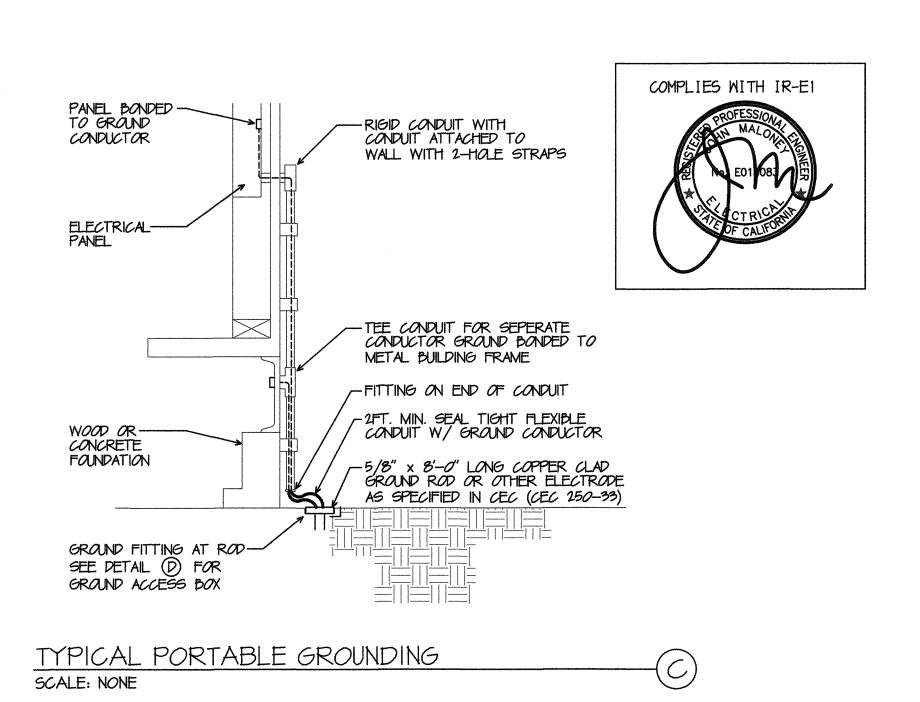

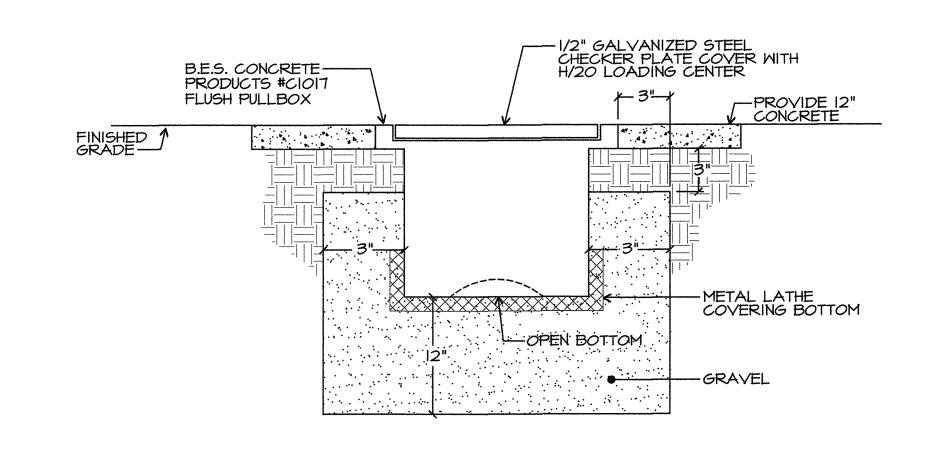

FLUSH PULLBOX DETAIL

SCALE: NONE

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ELECTRICAL ENGINEERING
LIGHTING DESIGN

CA REGISTRATION NO E13083

16136

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DRAWN BY: AC

CHK'D BY: WR


ISSUE DATE: 06/22/2016

SHEET TITLE

DETAILS

SHEET NUMBER

E-0.1

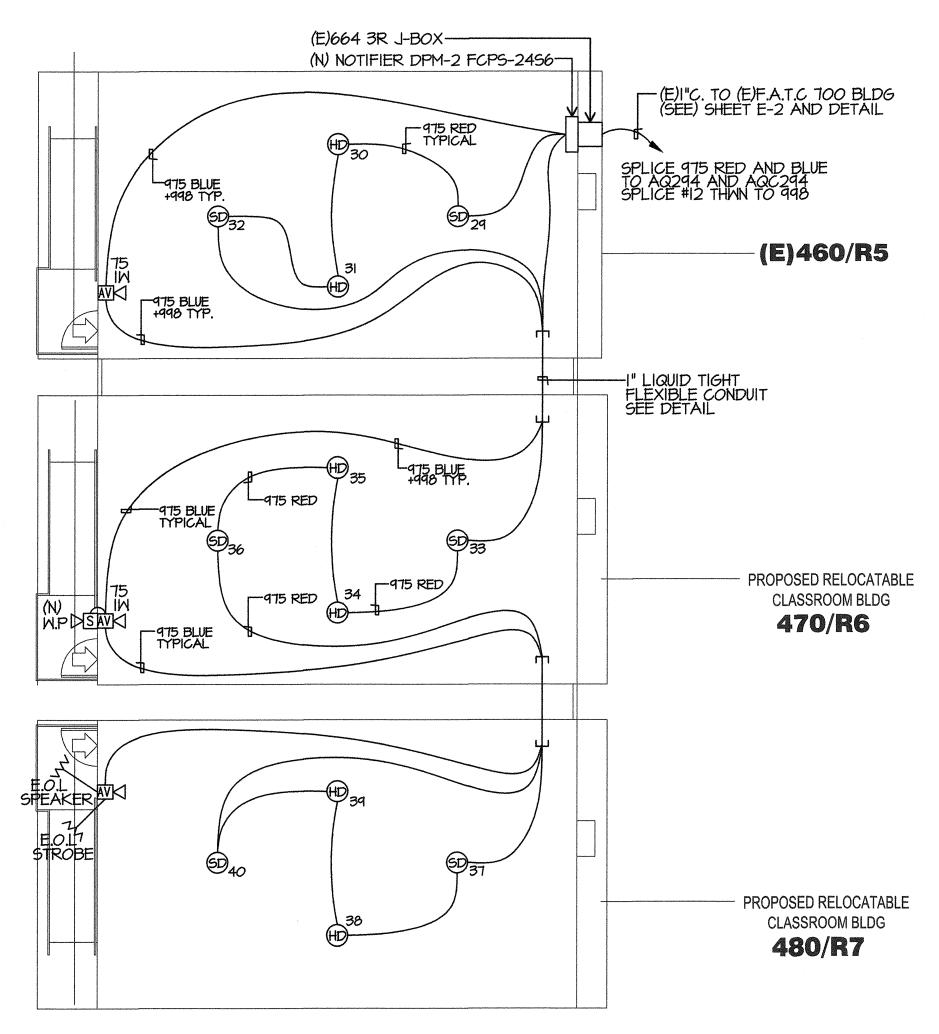


FIRE ALARM TYPICAL PORTABLE PLAN

SCALE: 1/8"=1'-0"

		VOLTA	GE DRO	P CALCULAT	TONS	
CIRCUIT	2x	LENGTH x	AMPS x	RESISTANCE x	= VOLTS	VOLTAGE DROP
N21	2	200	0.474	0.00205	0.389	1.62 %

	F	A SYMBOL L	IST MATRIX	
SYMBOL	DEVICE	MFR & CAT N.	REMARKS	CSFM LISTING
(SD)	SMOKE DETECTOR	NOTIFIER FSP-851	PROVIDE BASE B210 LP ON 4"SQ. DEEP BOX	7272-0028:0206
₩ M	SPEAKER/STROBE	NOTIFIER SPSR	PROVIDE 4"SQ. DEEP BOX	7320-1653:201
S MP	EXTERIOR SPEAKER	NOTIFIER SRRK	PROVIDE MMBB >96"	7320-1653:201
Œ	HEAT DETECTOR (IN ATTIC SPACE)	NOTIFIER FST-851	PROVIDE BASE B210 LP ON 4"SQ. DEEP BOX	7270-0028:0196
	(N)MAIN FIRE ALARM PANEL	NOTIFIER NFS2-640	PROVIDE (2) DEDICATED PHONE LINES	7165-0028:0243
DPM	NAC POWER	NOTIFIER FCPS-24S6		7315-0028:0225
DVO	DIGITAL VOICE COMMAND	NOTIFIER DVC-EM	SURFACE MOUNT	7165-0028:0224
DAA	DIGITAL AUDIO AMP	NOTIFIER DAA-5025	PART OF DVC	7165-0028:0224
M	END OF LINE RESISTOR			
	AQ294 CABLE	WEST PENN		7161-0859:0101
	AQC294 CABLE	WEST PENN		7161-0859:0101
	975 CABLE	WEST PENN		7161-0859:0101

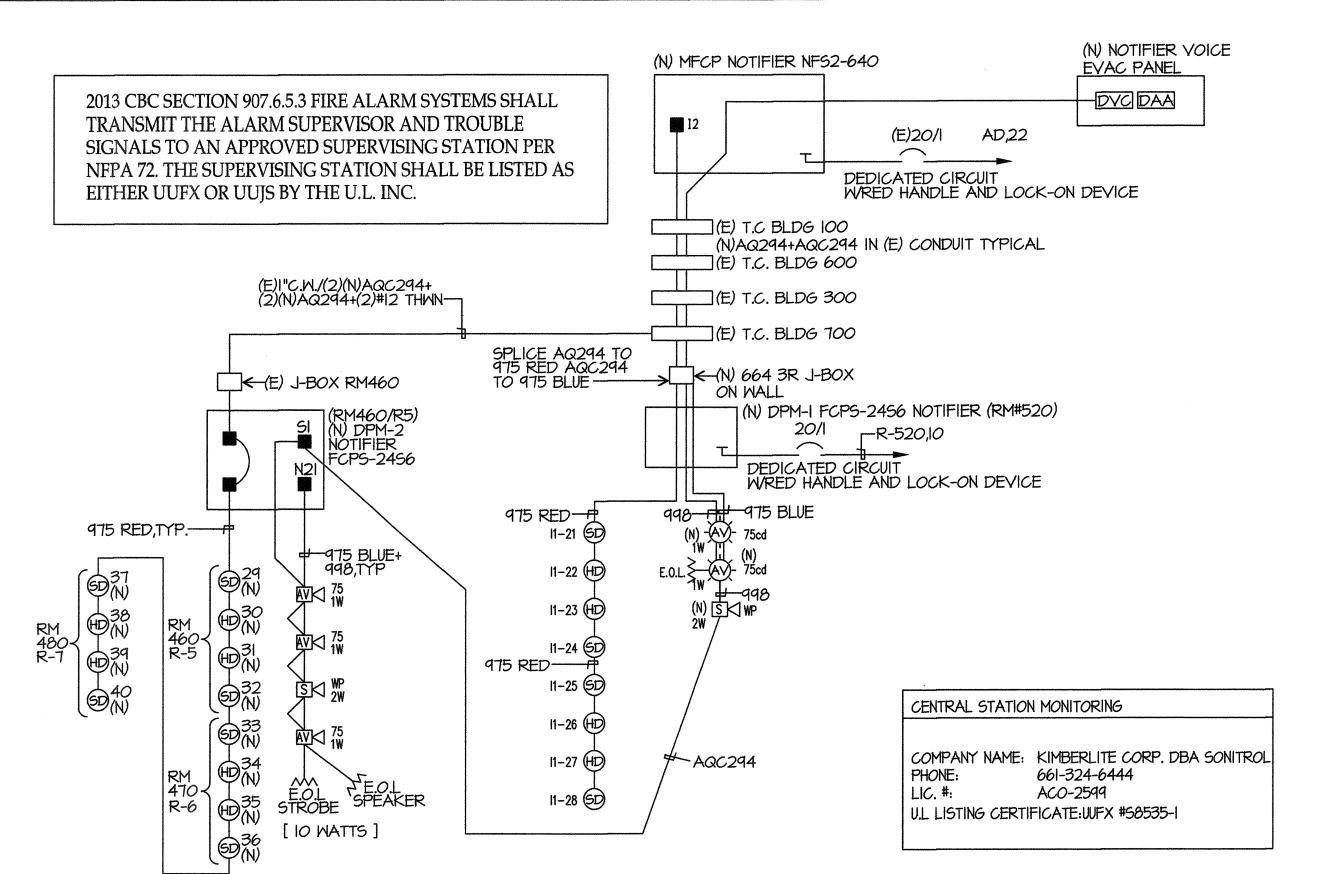

FIRE ALARM RISER DIAGRAM

SCALE: NONE

FIRE ALARM SEQUENCE (OF OPERA	TION		Acquire to the control of the contro
RESPONSE	AREA SMOKE DETECTOR	AREA THERMAL DETECTOR	FULL STATION	AC POWER FAILURE
ANNUNCIATE AT FIRE CONTROL ROOM ALARM AND TROUBLE	YES	YES	YES	YES (TROUBLE)
CENTRAL STATION MONITORING	YES	YES	YES	YES
ACTIVATE AUDIO VISUAL THROUGHOUT FLOOR OF ALARM	YES	YES	YES	YES
CENTRAL STATION MONITORING	YES	YES	YES	YES
ACTIVATE VOICE EVACUATION	YES	YES	YES	NO

DEVICE NUMBER	ING LEGEND
DEVICE ADDRESS: DEVICE SYMBOL DEVICE REFERENCE NUMBER CIRCUIT NUMBER INITIATION	N I-I AV 75cd CANDELA SETTING DEVICE SYMBOL DEVICE REFERENCE NUMBER CIRCUIT NUMBER NOTIFICATION

DPM-2				SUPE	RVISORY		ALARM
EQUIPMENT DE	SCRIPTION	QUANTITY	Alongo data giranda saraman di dada salah 190 kiloki bir Kiloki (1999-19),		URRENT	_	JRRENT
			and the second s		IPERES)		PERES)
		EXISTING	NEW	EACH	SUB-TOTAL		SUB-TOTAL
DISTRIBUTED POWER MOD	JLE	0	1	0.065		0.145	0.14
FCM-1		0	1	0.0003	0.0003	0.0003	0.0003
		0	0	0	0	0.062	
VISUALS	15 cd	0	0	0	0	0.066	(
VISUALS	15/75 cd	0		0	0	0.077	
VISUALS	30 cd	0	0	0	0	0.094	
VISUALS	75 cd	0	3	0	0	0.158	0.47
VISUALS	95 cd	1 0	0	0	0	0.202	
		0	0	0	0	0	(
		0	0	0	0	0	
					0		
OUD TOTAL ALABEDEO		0]	0	0.0653	AMPO	0.6193	AME
SUB TOTAL AMPERES							
				x 24 HOUF		X 0.25 HO	
SUB TOTAL AMPERE-HOUR	5			1.5672	A.H.	0.154825	A.H.
TOTAL REQUIRED AMPERE-			DULE			1.722025	A.H.
BATTERY NON-LINEAR DISC	HARGE CHARACTERIS	STIC FACTOR					x 1.2
TOTAL MINIMUM AMPERE H	OURS REQUIRED	and the state of t				2.06643	A.H.
PROVIDED BATTERY CAPAC	CITY					7.00	A.H.

			SUPE	RVISORY		ALARM		
FOLIPME	EQUIPMENT DESCRIPTION		QUANTITY		CURRENT		CURRENT	
Cymrefernia mae ddireanir ha'r fariddiddir ddirea gantau, pau am'r cyf ympar y am'r gant acantau a angarau, am'r ardrif rae	EQUIFIVENT DECONITION QUA			(AMPERES)		(AMPERES)		
		EXISTING	NEW		SUB-TOTAL	EACH	SUB-TÓTAL	
DVC		0	1	0.44	0.44	0.44	0.44	
DAA 5025		0	1	0.35	0.35	1.9	1.9	
					0		0	
1/4 Watt Speaker		0	0	0	0	0.017	0	
1 Watt Speaker		0	5	0	0	0.068	0.34	
2 Watt Speaker		0	2		0	0.132	0.264	
		0	0		0	0	0	
VISUALS	75 cd	0	0		0	0.158	0	
VISUALS	30 cd	0	0	0	0	0.094	C	
VISUALS	15 cd	0	0	0	0	0.066	C	
		0	0	0	0	0	0	
					0		0	
		0	0	0	0	0	0	
SUB TOTAL AMPERE	S			0.79	AMPS	2.944	AMPS	
				x 24 HOUF	रड	X 0.25 HO	URS	
SUB TOTAL AMPERE	-HOURS	er oppiration		18.96	A.H.	0.736	A.H.	
		90					Display	
TOTAL REQUIRED AN	PERE-HOURS FOR DISTRI	BUTED POWER	R MODULE	-		19.696	A.H.	
BATTERY NON-LINEA	R DISCHARGE CHARACTE	RISTIC FACTOR	₹				x 1.2	
TOTAL MINIMUM AMF	PERE HOURS REQUIRED	and of the state o				23.6352	A.H.	
Existing BATTERY CA	PACITY					55.00	A.H.	

:			SUPER	RVISORY	AL	ARM
EQUIPMENT DESCRIPTION	QUAN	ITITY	CUR	RRENT	CUR	RENT
	a gasa planineth à diproventier, descrive de la planinet avec an infection replanet produces and infection replanet projection of the contract	Derland Hilliam Art of the Art Commission (and State Commission Art	(AM	PERES)	(AM	PERES)
	EXISTING	NEW	EACH	SUB-TOTAL	EACH	SUB-TOTAL
FIRE ALARM PANEL	1	0	0.1	0.1	0.1	0.1
DIGITAL ALARM COMMUNICATOR	1	0	0.02	0.02	0.02	0.02
SUPERVISED OUTPUT MODULE			0.00022	0	0.0003	C
			0	0	0	C
SMOKE DETECTOR	9	6	0.00039	0.00585	0.00039	0.00585
HEAT DETECTOR	7	6	0.00035	0.00455	0.00035	0.00455
HORNS	8	0		0	0.062	0.496
AUDIBLE/VISUALS 75 cd	18	0		0	0.121	2.178
AUDIBLE/VISUALS 15 cd	21			0	0.052	1.092
SUB TOTAL AMPERES			0.1304	1	3.8964	
			x 24 HOUI		x 0.25 HO	
SUB TOTAL AMPERE-HOURS			3.1296	A.H.	0.327298	A.H.
TOTAL REQUIRED AMPERE-HOURS FOR DIST			E		3.456898	A.H.
BATTERY NON-LINEAR DISCHARGE CHARA	CTERISTIC FACT	OR		O Para Control	1	x 1.2
TOTAL MINIMUM AMPERE HOURS REQUIRE	D				4.148277	A.H.
BATTERY AH SUPPLIED (NEW)				4	26.00	A.H.

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ARCHITECTURE PLANNING

San Luis Obispo
4115 Broad Street, Suite B-6
San Luis Obispo, CA 93401
805.546.0433 fax:805.546.0504

* No. C18079 *
REN. 10/17

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BAKERSFIELD CITY SCHOOL



CHIPMAN JR. HIGH RELOCATABLES R-6 & R-7

2905 EISSLER ST BAKERSFIELD, CA 93306


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PROJECT NO:	16132.000
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CHK'D BY:	WR
ISSUE DATE:	06/22/2016
SHEET TITLE	

FIRE ALARM RISER CALCULATIONS


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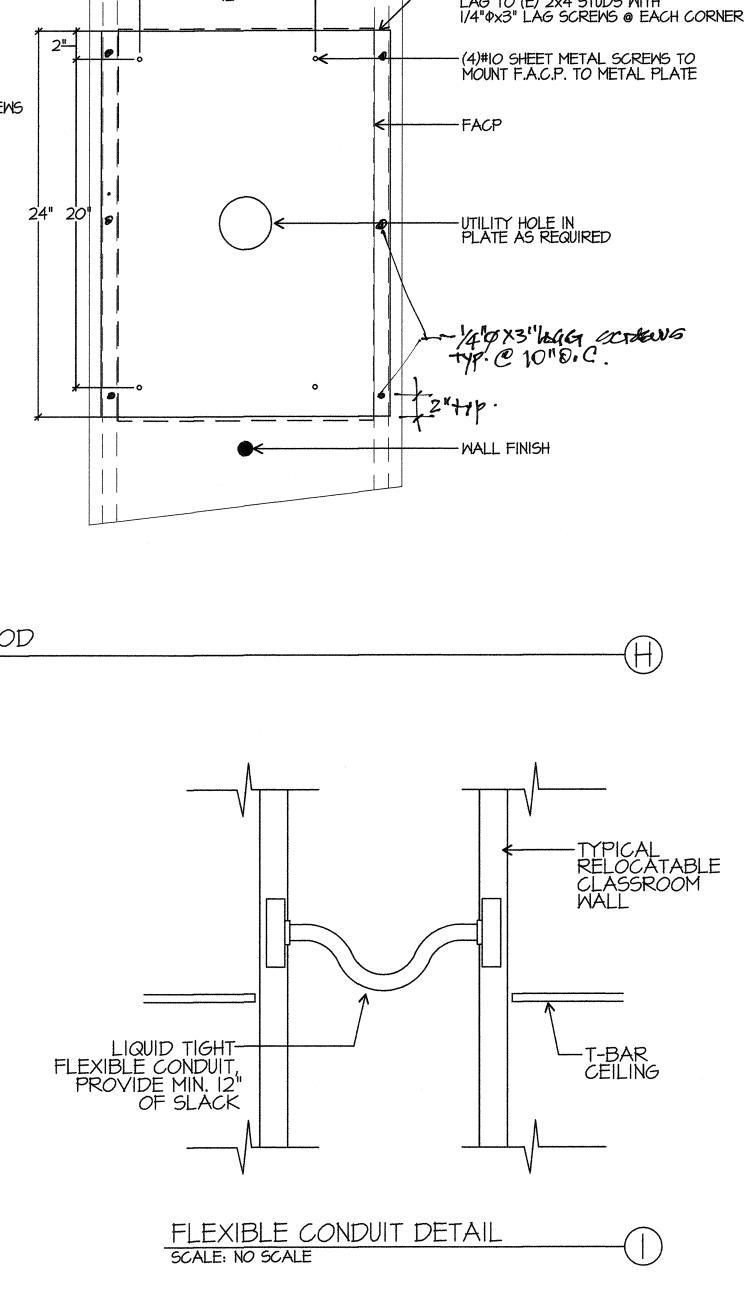
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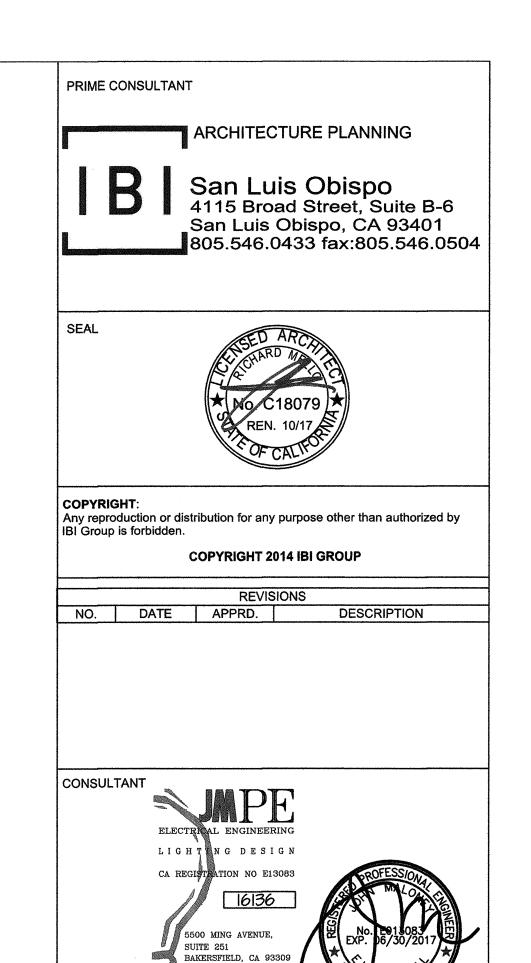
OT DATE: 5/10/2016



SCALE:1/4"=1'-0"

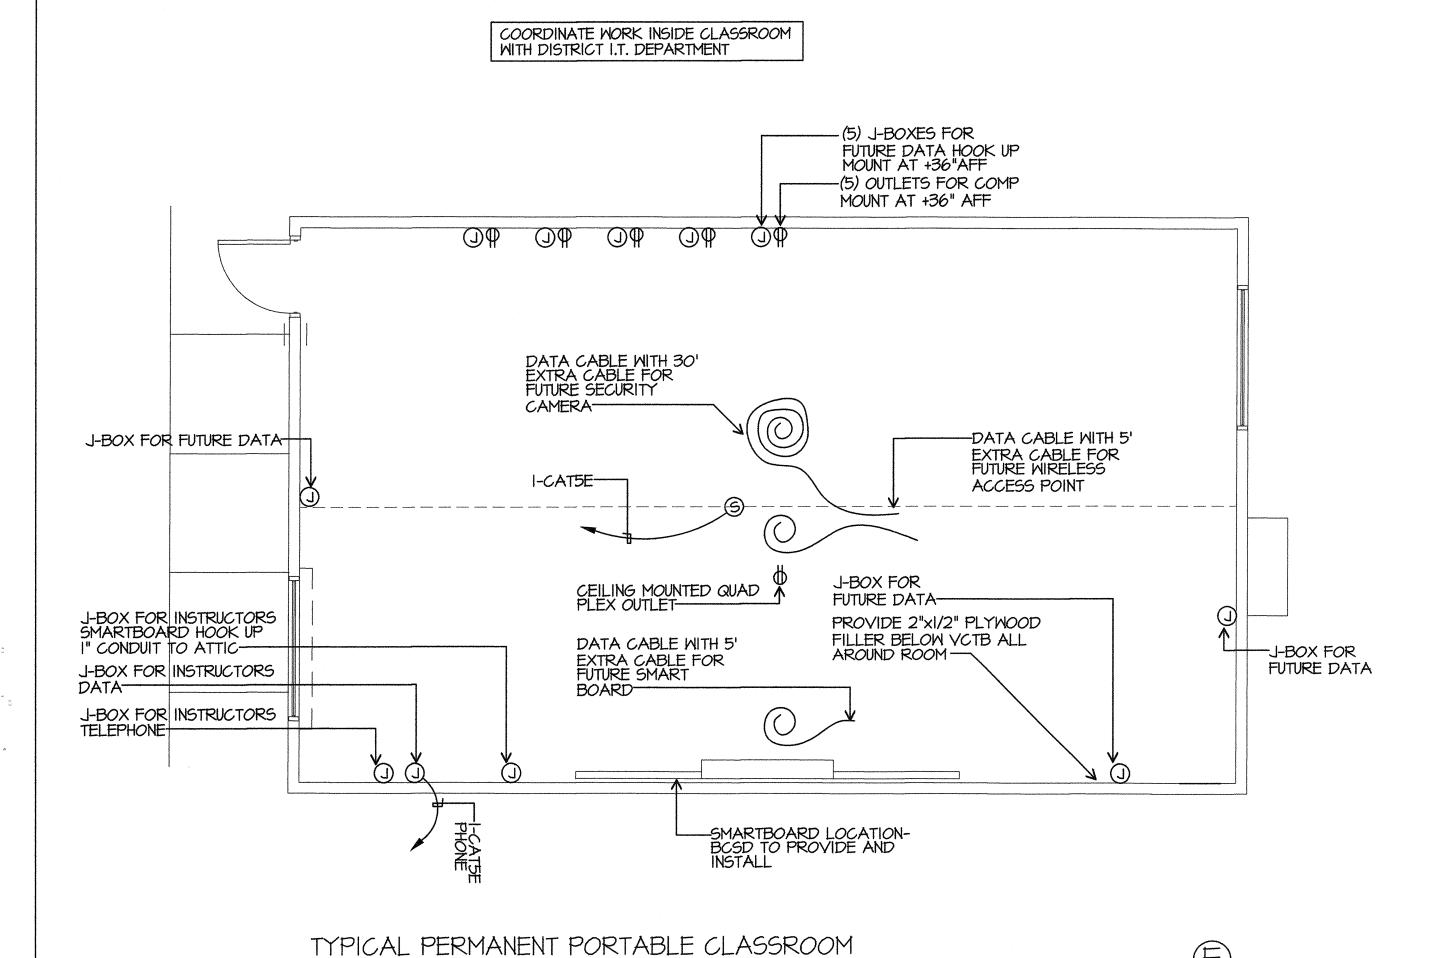



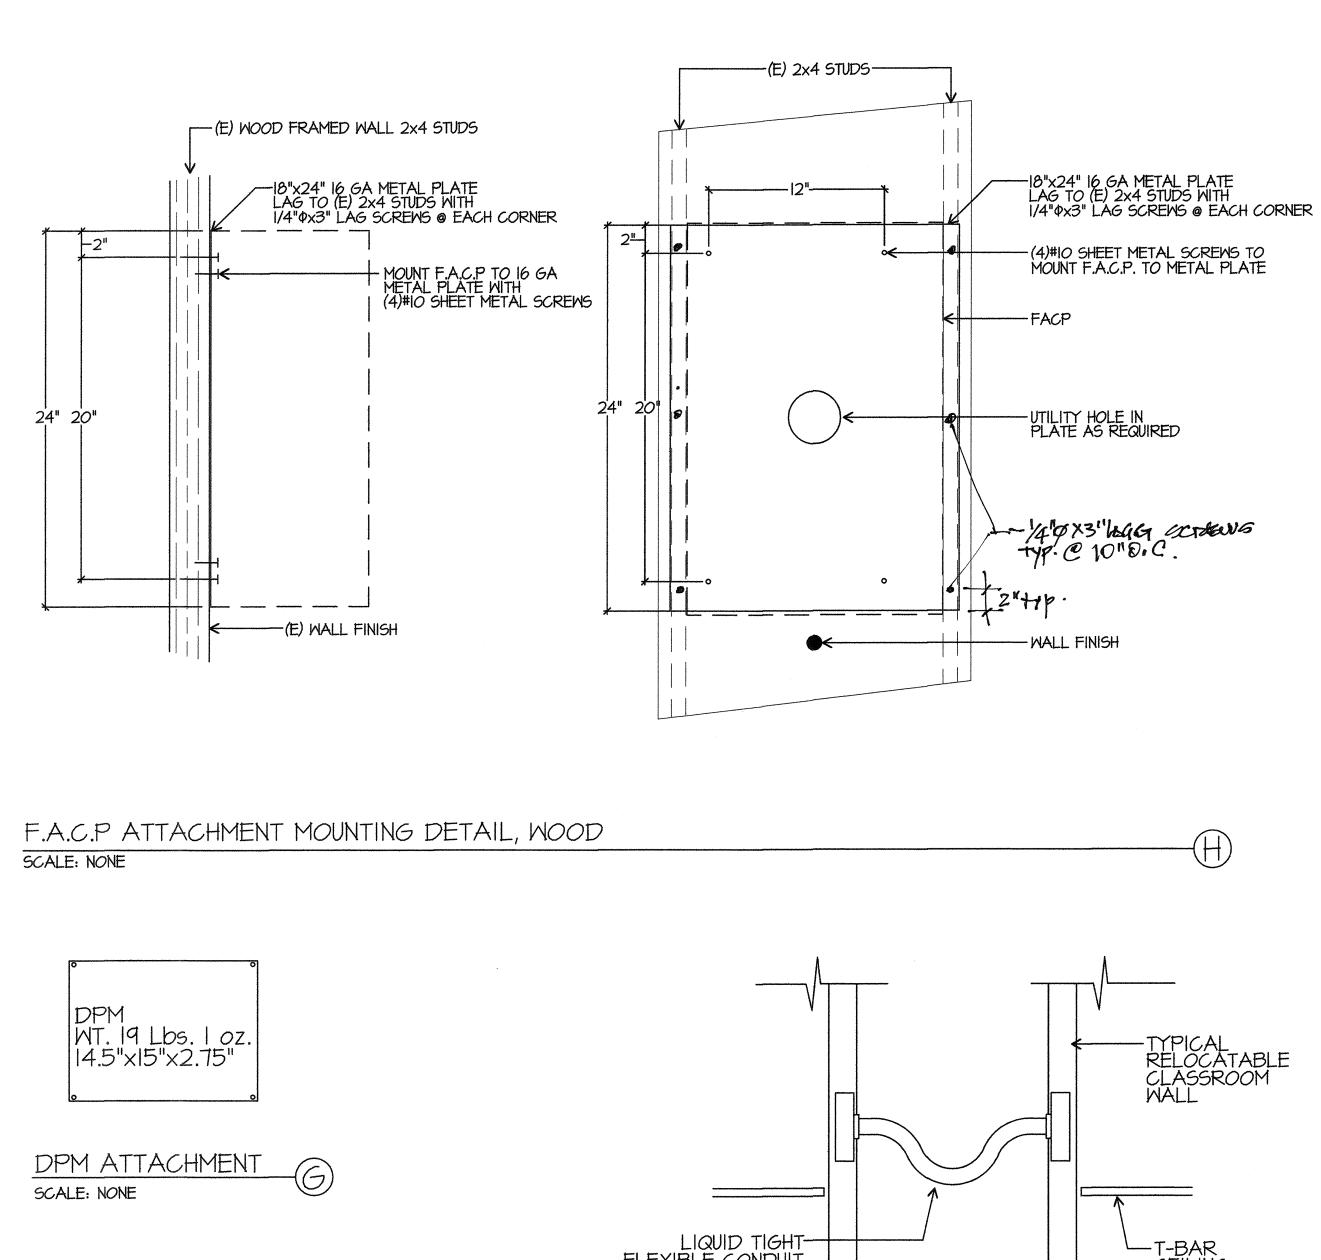

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BAKERSFIELD CITY SCHOOL DISTRICT



CHIPMAN JR. HIGH **RELOCATABLES R-6 & R-7**


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PROJECT NO:	16132.000
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ISSUE DATE:	06/22/2016
SHEET TITLE	

DETAILS

SHEET NUMBER

E-0.3

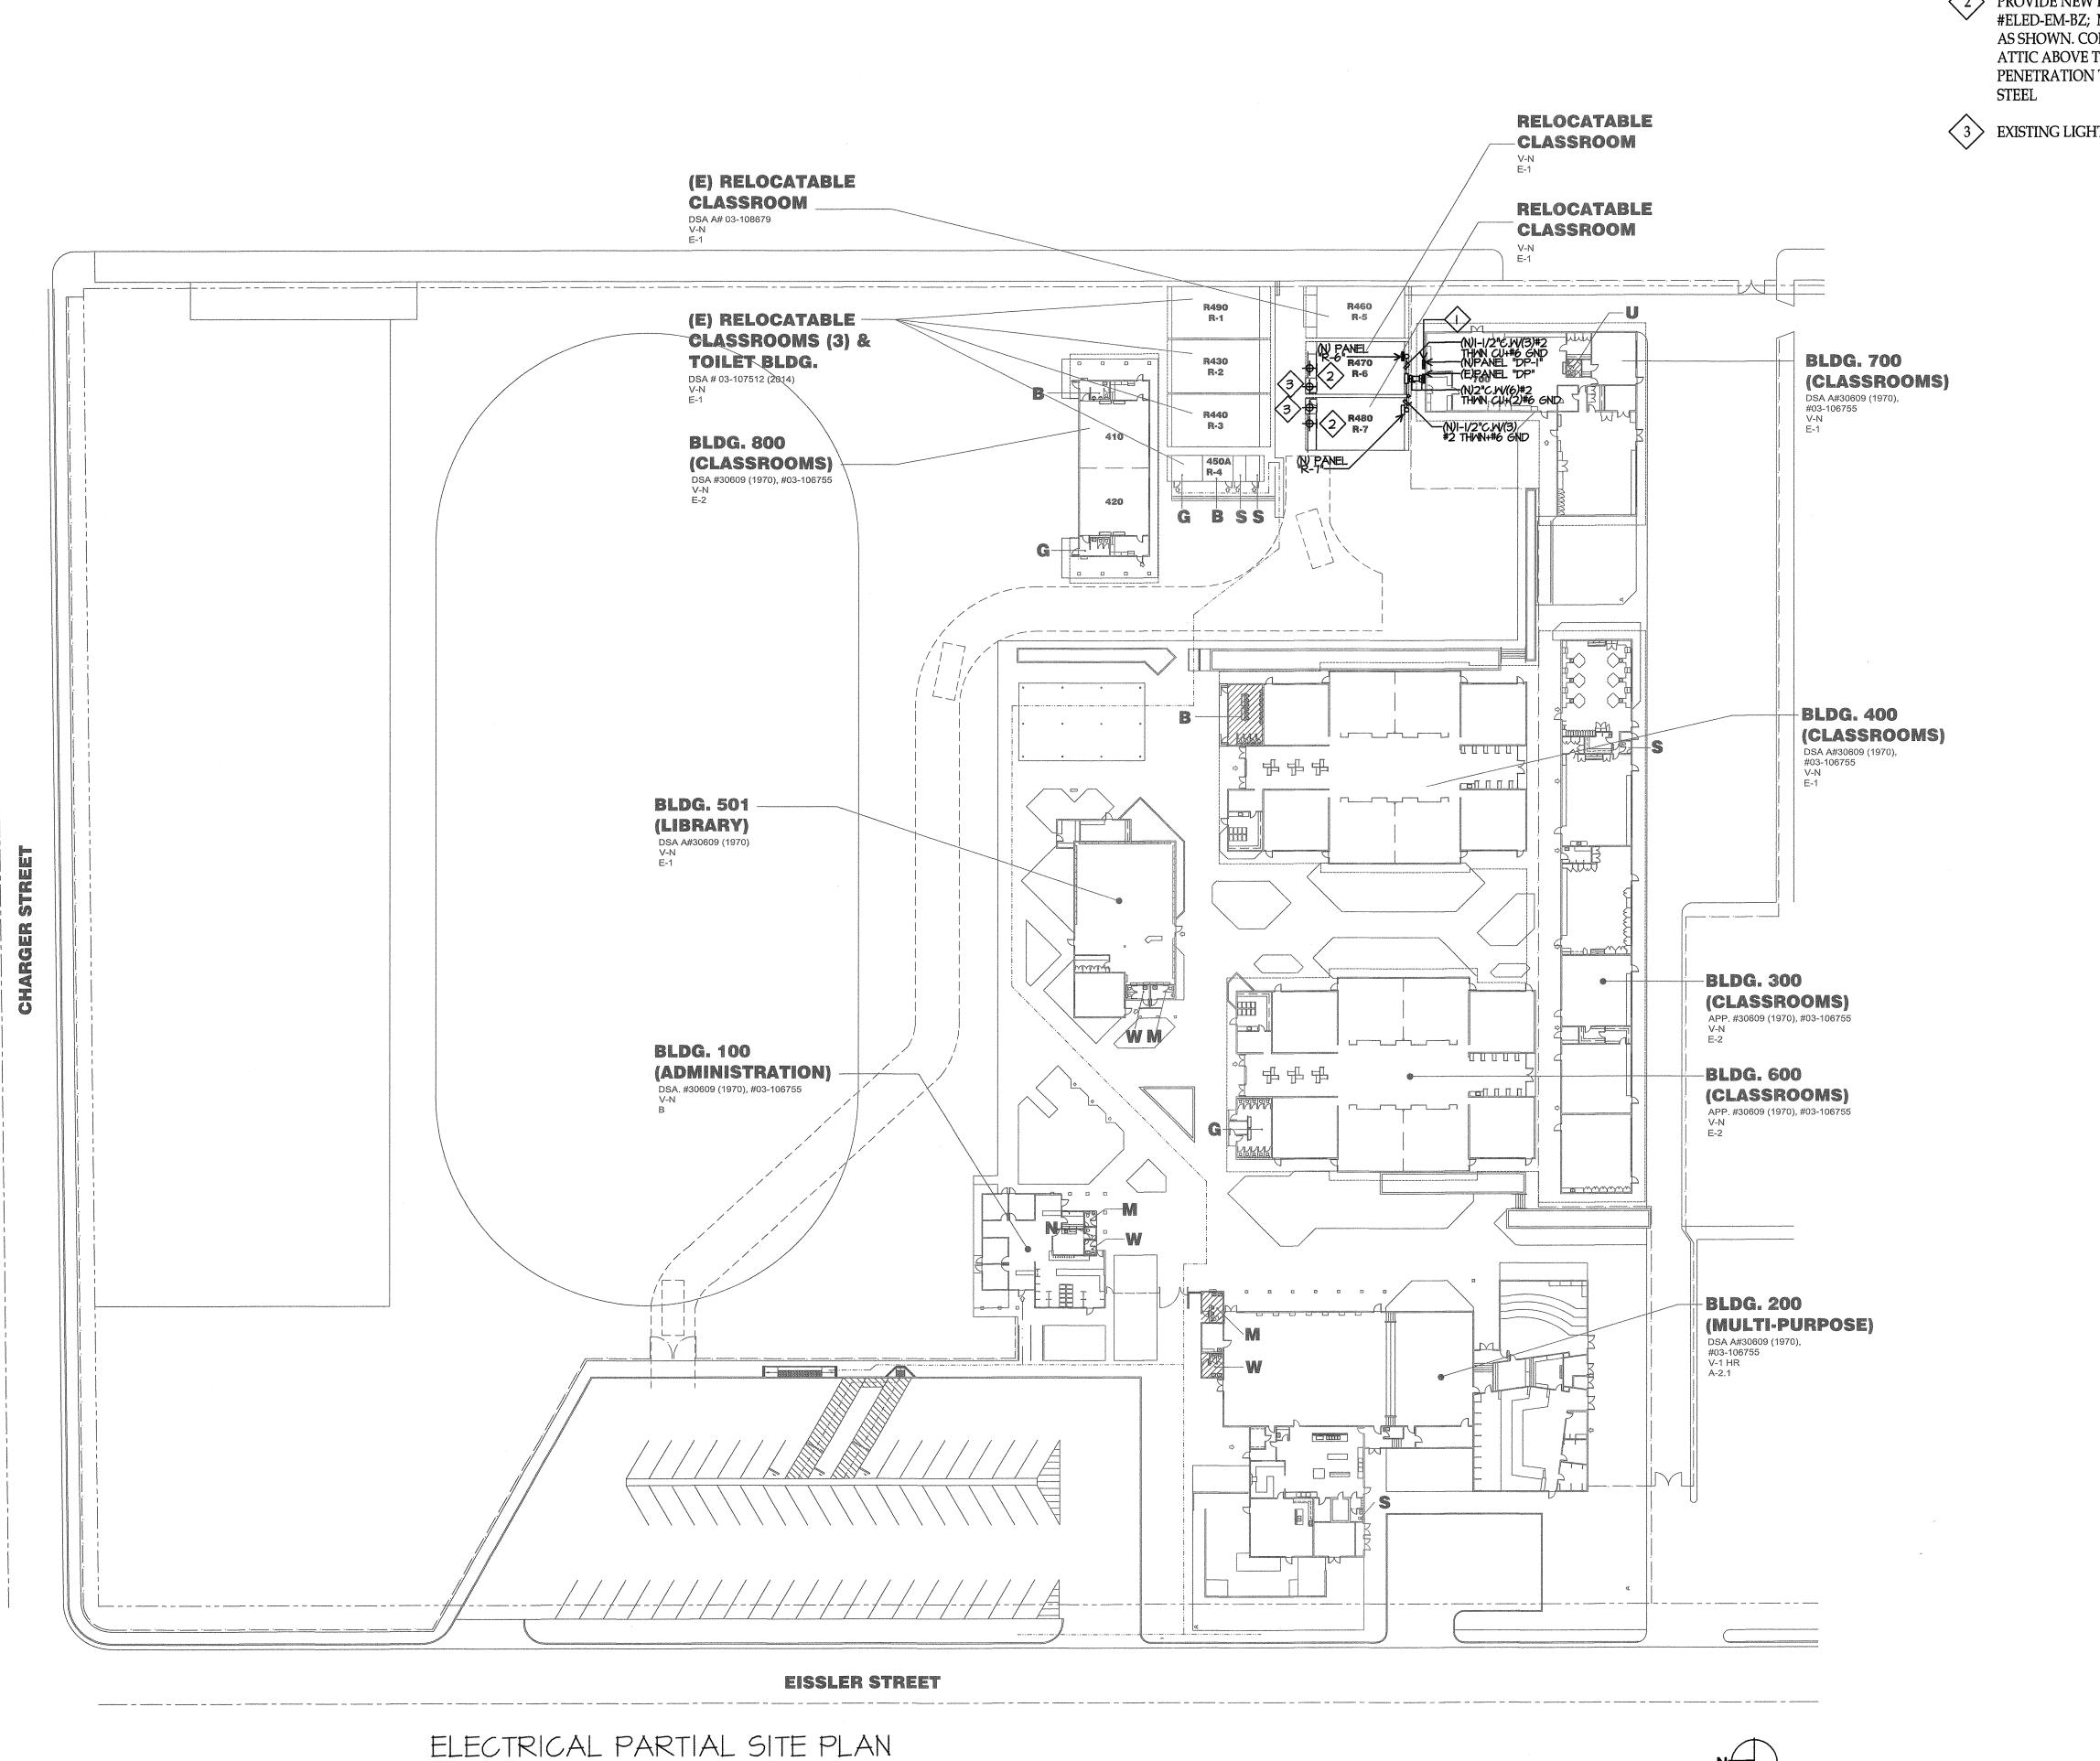

ELECTRICAL PARTIAL SITE PLAN NOTES

ADD (2)(N) 100/2 BREAKERS INTO PANEL DP-1.

PROVIDE NEW EMERGENCY EGRESS LIGHT. ISOLITE #ELED-EM-BZ; MOUNT IN CENTER OF FRONT EXTERIOR WALL AS SHOWN. CONNECT TO (E) UNSWITCHED LIGHT CIRCUIT IN ATTIC ABOVE T-BAR CEILING. FIELD VERIFY WALL PENETRATION TO BE ABOVE T-BAR AND BELOW BUILDING

(3) EXISTING LIGHT TO REMAIN.

SCALE: |"=40'-0"

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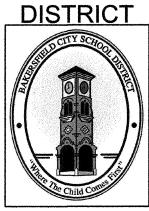
CONSULTANT

LIGHTING DESIGN CA REGISTRATION NO E13083 SUITE 251 BAKERSFIELD, CA 93308 (661) 831-7851 FAX (661) 831-7813 email: maloney@jmpowww.jmpe.net BAKERSFIELD, CA 93309

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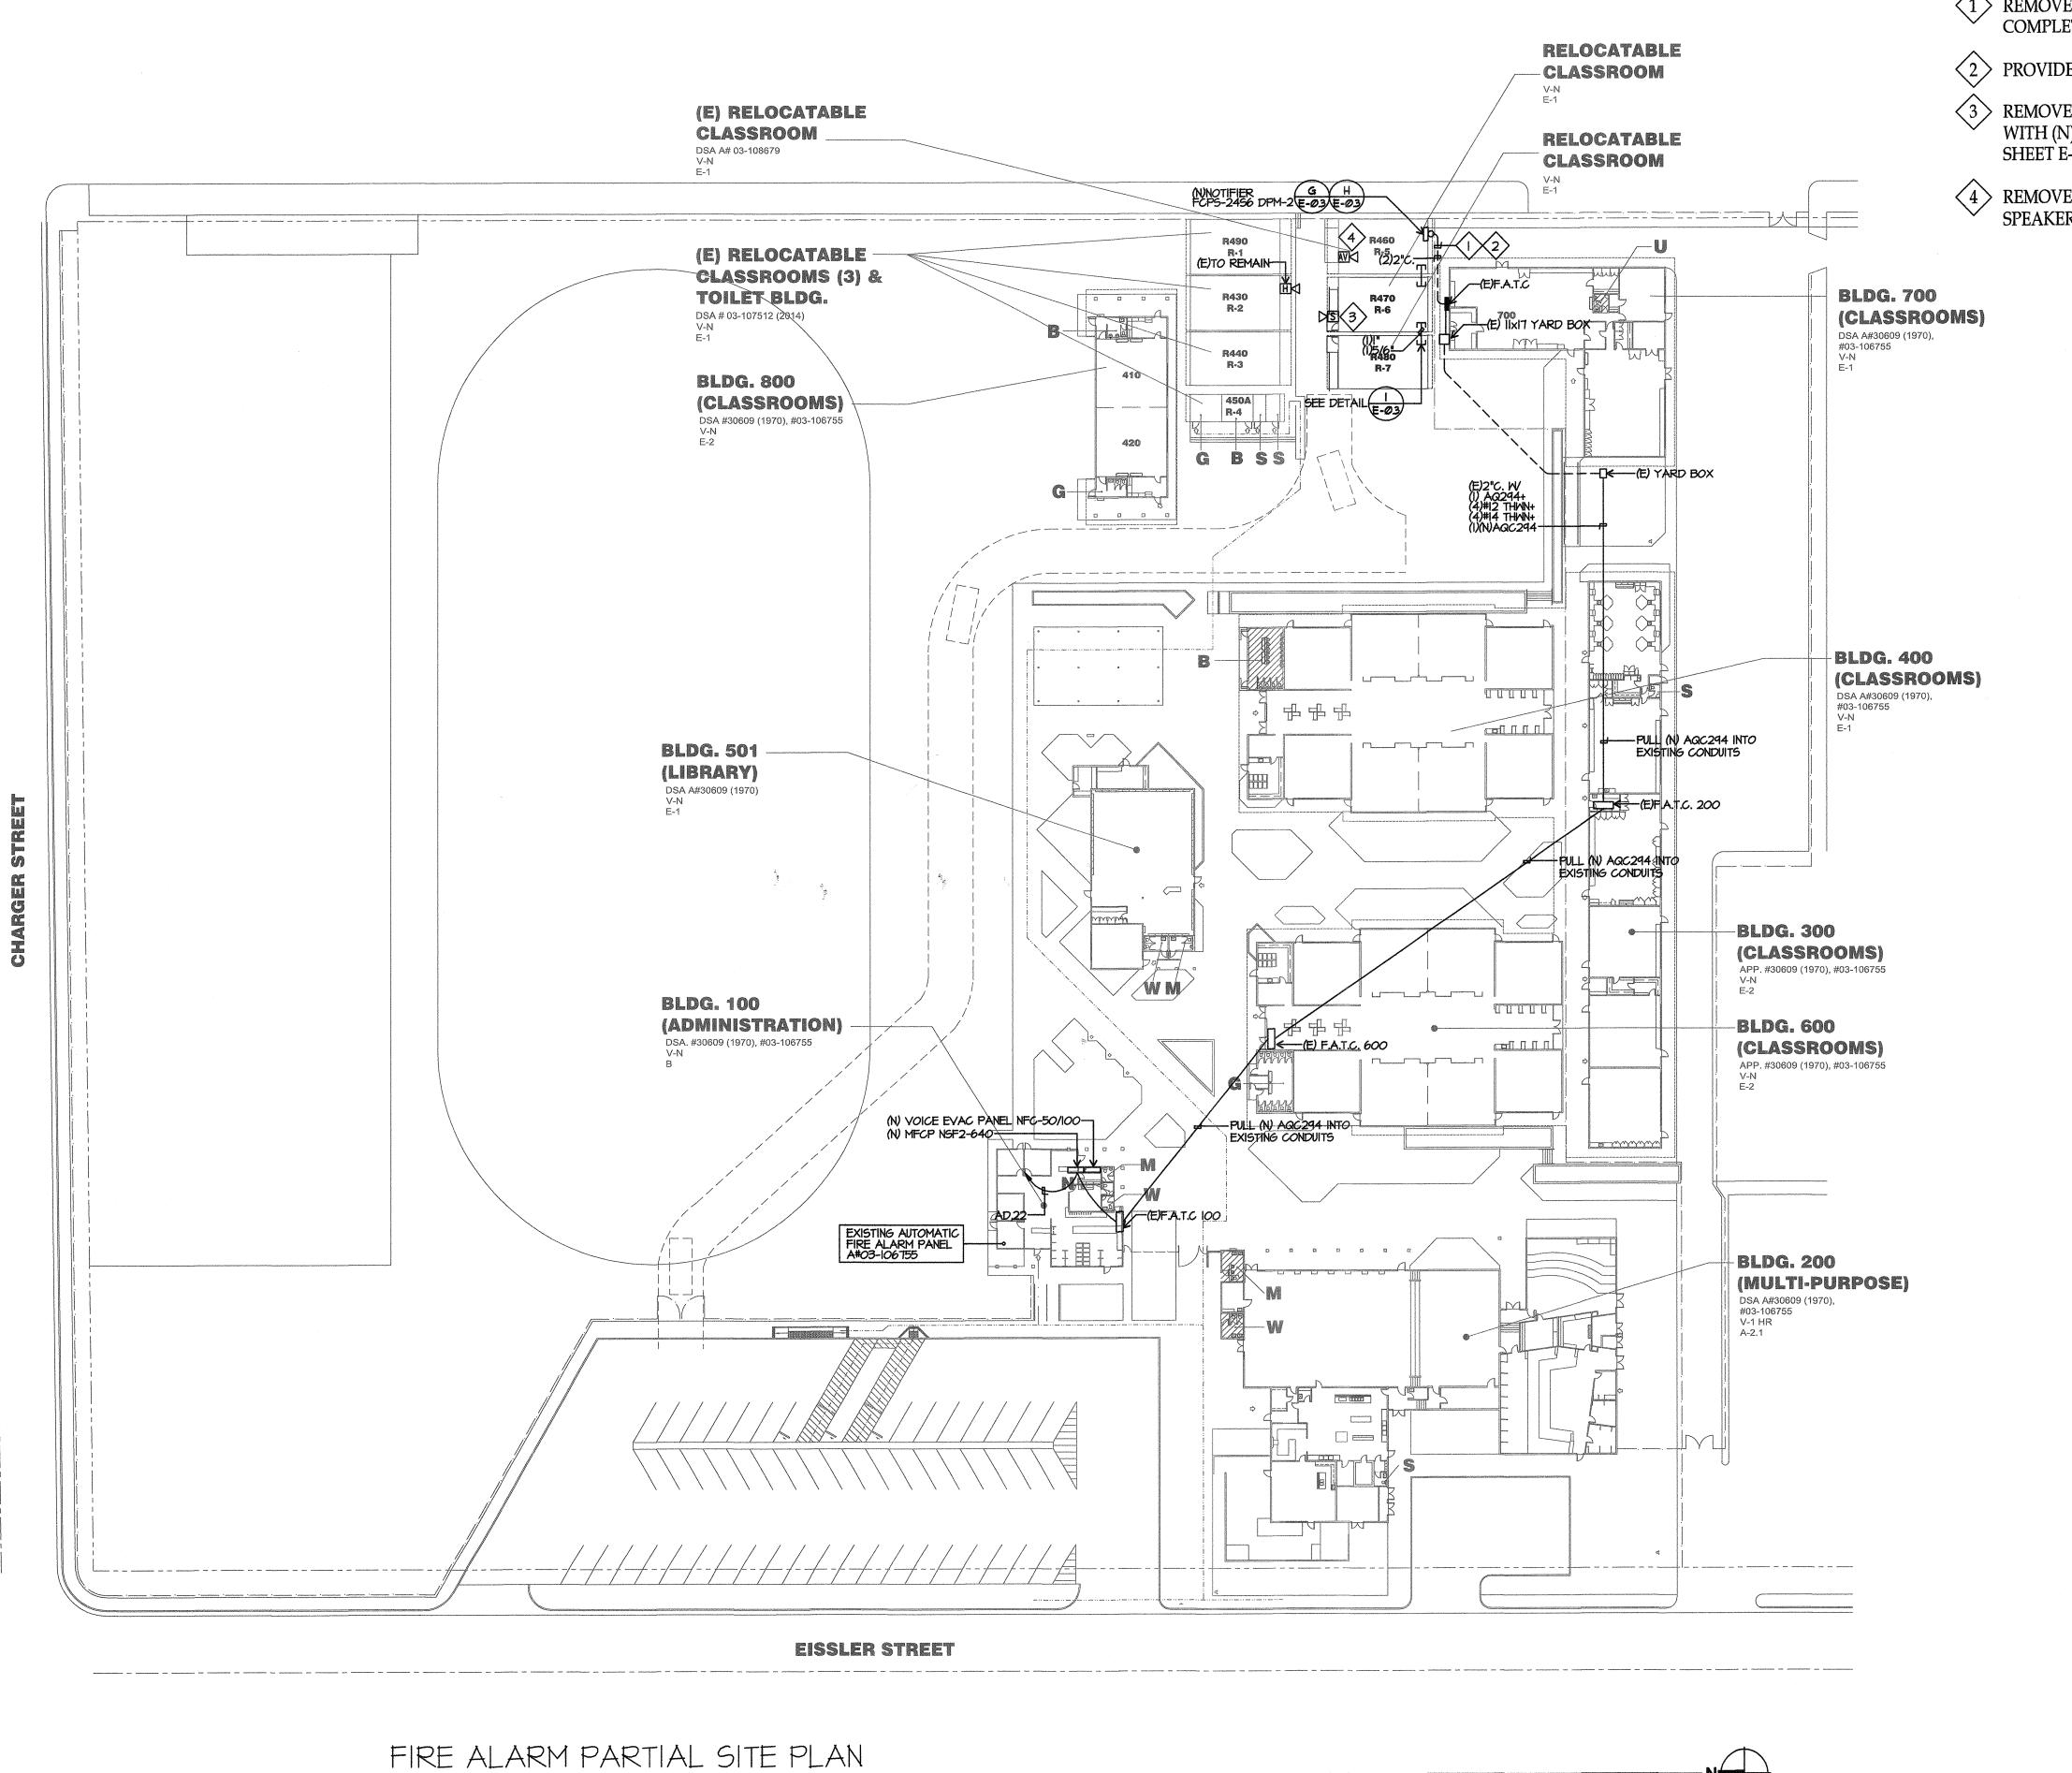


CHIPMAN JR. HIGH **RELOCATABLES R-6 & R-7**

2905 EISSLER ST BAKERSFIELD, CA 93306

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> **ELECTRICAL** PARTIAL SITE **PLAN**



PARTIAL FIRE ALARM SITE PLAN NOTES

REMOVE (E) CONDUCTORS FROM CONDUIT COMPLETELY.

(2) PROVIDE (2)(N) AQ294+(2)(N) AQC294.

REMOVE EXISTING EXTERIOR HORN AND REPLACE WITH (N) EXTERIOR W.P. SPEAKER SEE RISER DETAIL® SHEET E-.02.

4 REMOVE (E) A/V IN ROOM AND REPLACE WITH (N) SPEAKER/STROBE. SEE RISER DETAIL (A) SHEET E-0.2

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BAKERSFIELD CITY SCHOOL DISTRICT



CHIPMAN JR. HIGH **RELOCATABLES R-6 & R-7**


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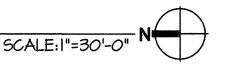
> FIRE ALARM PARTIAL SITE **PLAN**

SHEET NUMBER

E-2



DATA/COMM. PARTIAL SITE PLAN

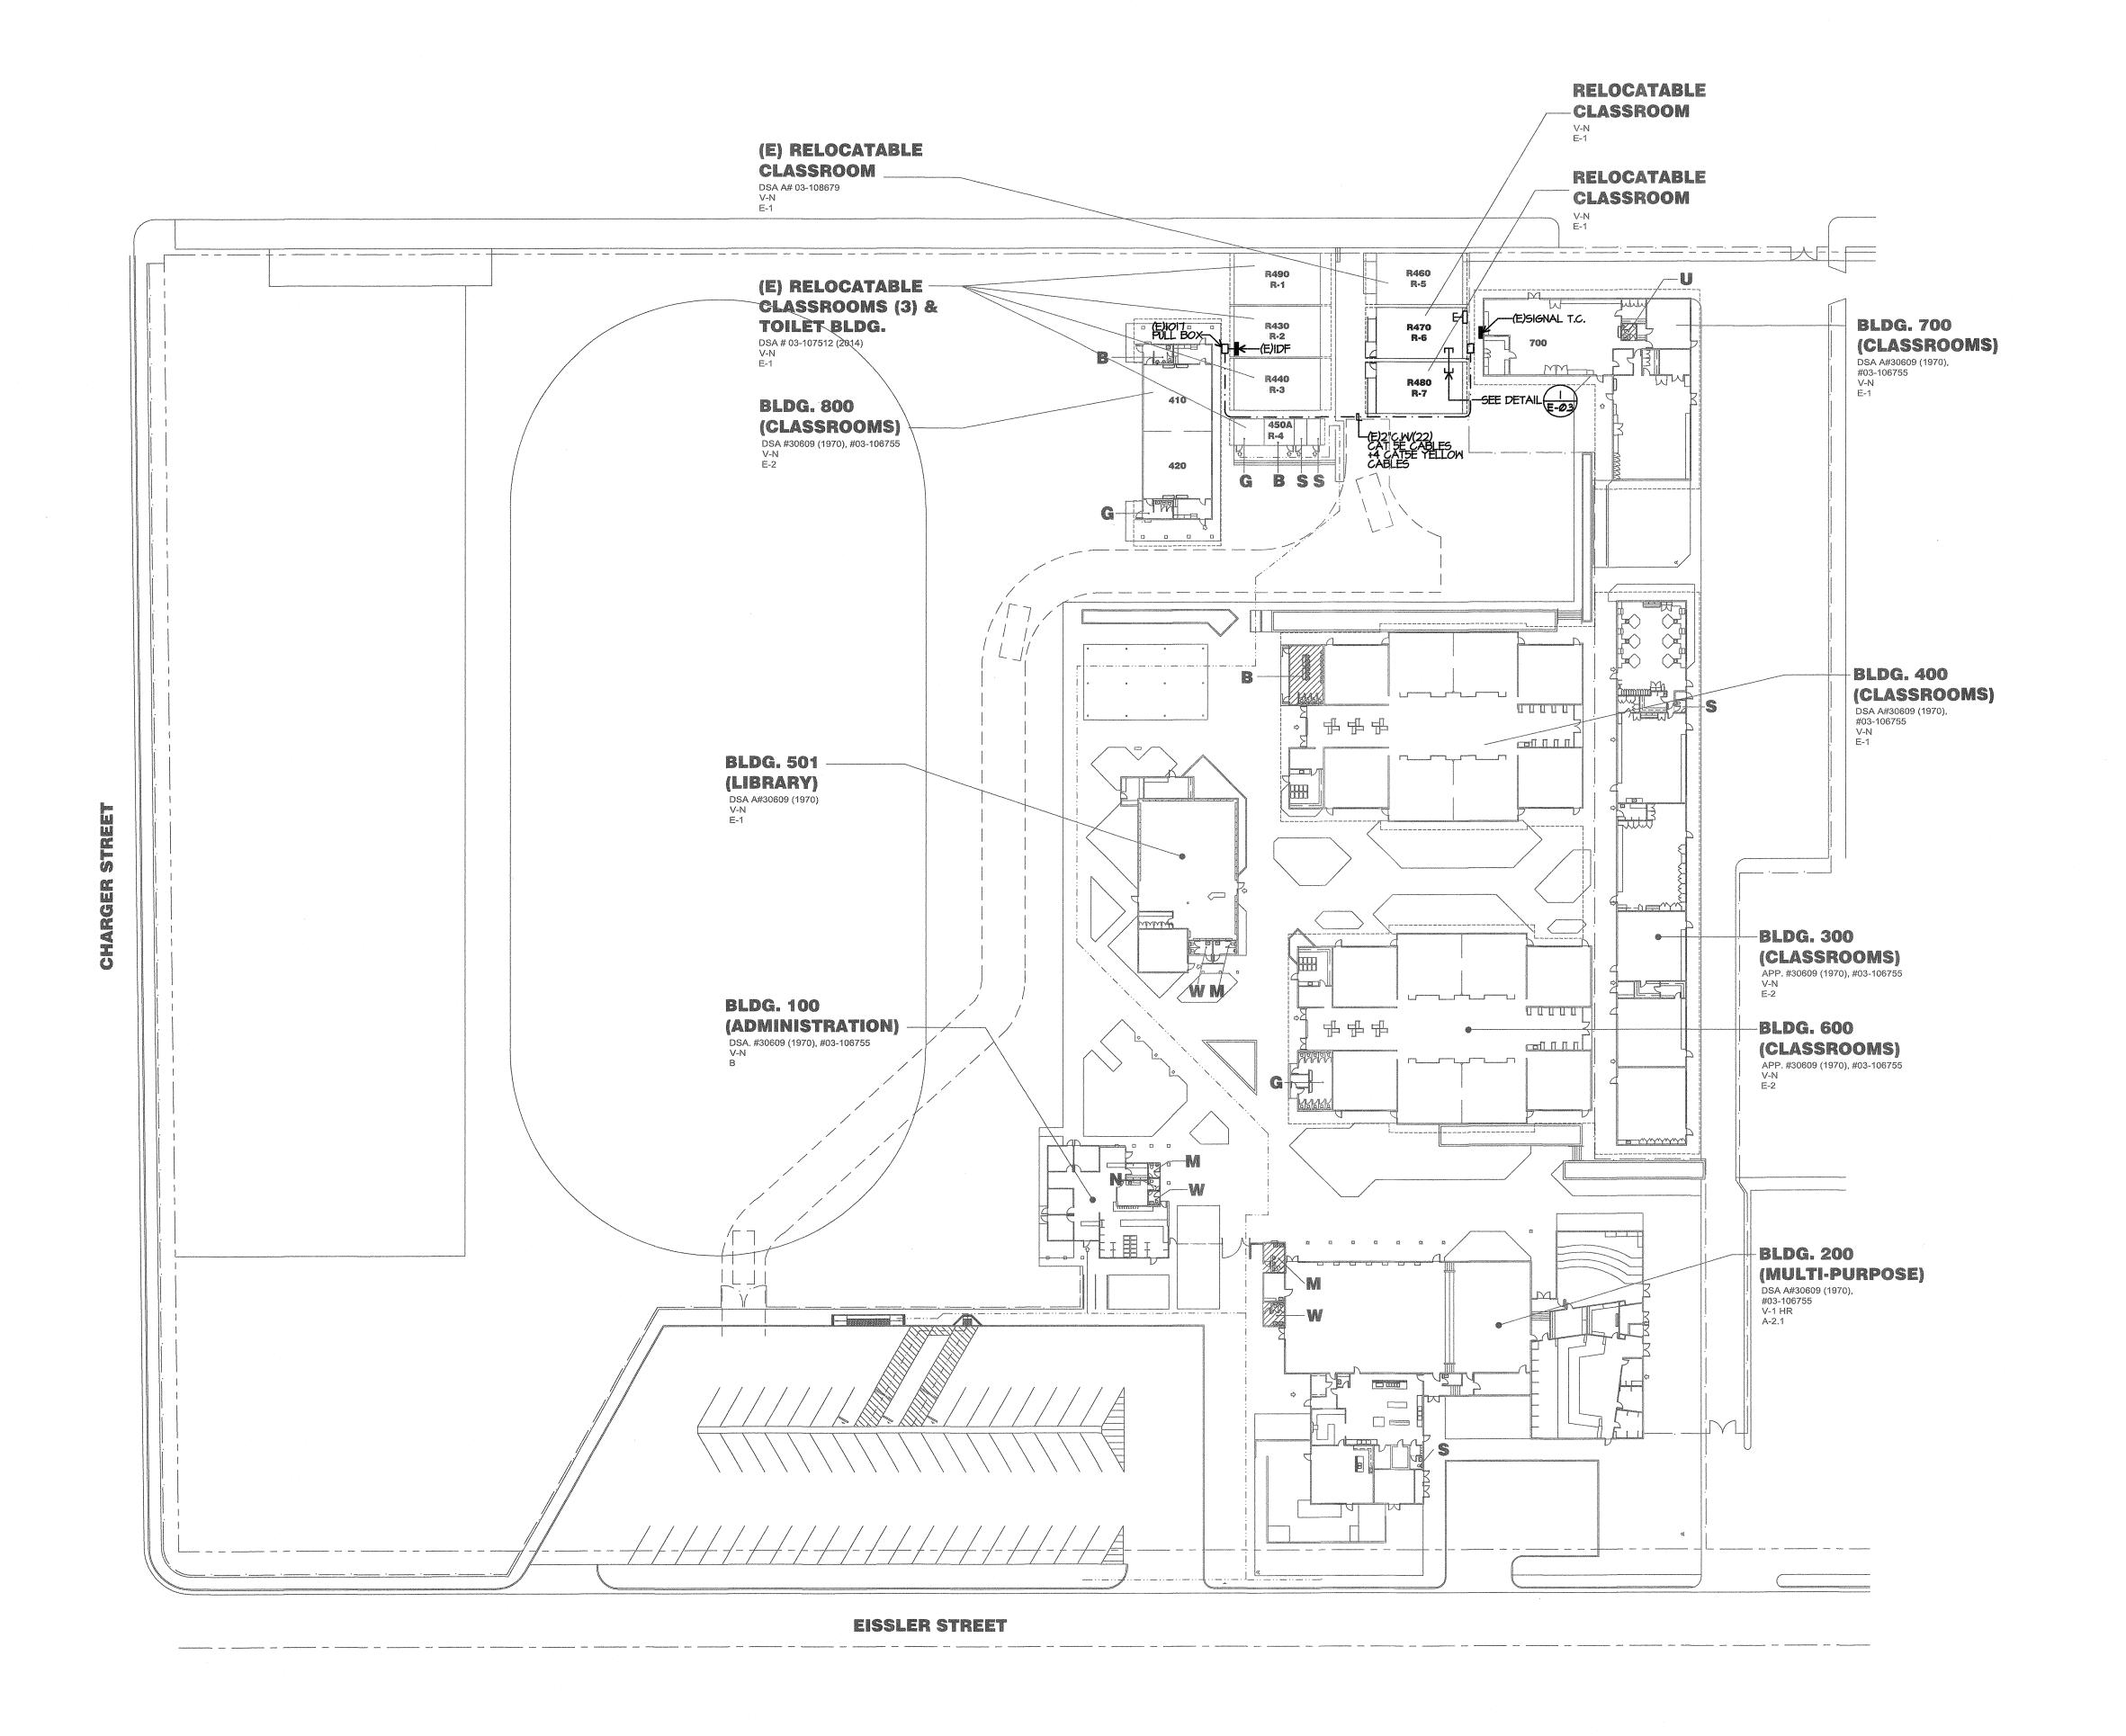

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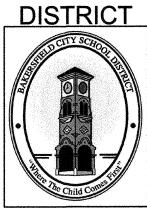
BAKERSFIELD, CA 9330 (661) 831-7851 FAX (661) 831-7813 email : maloney@jmp www.jmpe.net BAKERSFIELD, CA 93309

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> DATA/COMM. **PARTIAL** SITE PLAN