



OCLASSROOM BUILDING MECHANICAL FLOOR PLAN SCALE: 1/8" = 1'-0"




KINDERGARTEN BUILDING MECHANICAL FLOOR SCALE: 1/8" = 1'-0"

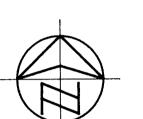

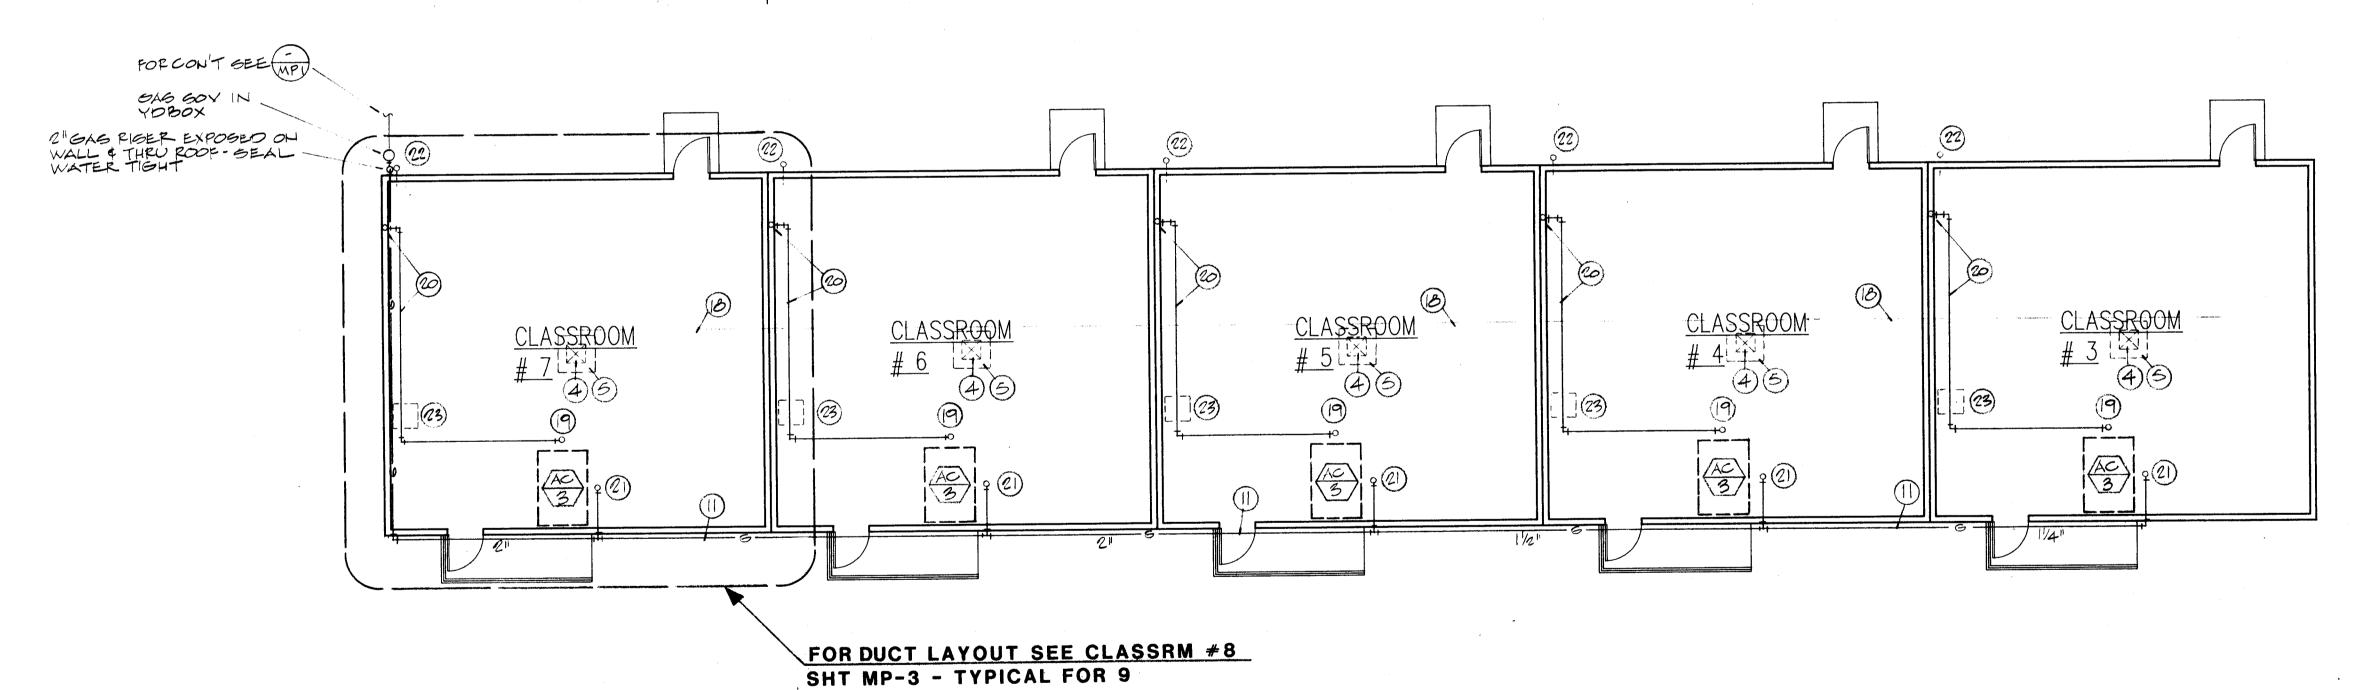

3 CLASSROOM SCALE: 1/8" = 1'-0" 5 CLASSROOM WING NEXT TO KINDERGARTEN SEE MP-1

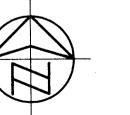

A.C. UNIT IS TO BE MOUNTED ON SHOP FABRICATED SHEET METAL CURB. ALSO CURB IS TO BE USED AS A RA PLENUM LINED WITH 1" -3 LB VINYL COATED GLASS FIBER LINING. SEAL WATER TIGHT. SEE A.C. MOUNTING DETAILS ON MECHANICAL AND STRUCTURAL DRAWINGS.

REMOVE EXISTING EVAPORATIVE COOLER. PROPERLY DISCONNECT BLECTRICAL AND CAP WATER LINE. REMOVE IF EXPOSED.

DUCT TO PASS THRU EXISTING WALL. CUT HOLE IN A NEAT MANNER AND FINISH WITH FLANGE ALL AROUND.

EXPOSED SPIRAL DUCT SUSPENDED BELOW 'T' BAR CEILING. INSTALL IN A NEAT MANNER. ALIGN SPIRALS AT JOINTS. EXISTING FURNACE TO BE REMOVED. CAP DUCTS AT WALL WITH SHEET METAL PANEL WITH HEMMED EDGES. FLUE THRU ROOF TO REMAIN. CAP WITH SHEET METAL PANEL AT CEILING. PROPERLY DISCONNECT ELECTRICAL AND REMOVE GAS PIPING TO CEILING.

EXISTING CONCRETE PIT TO BE FILLED IN AS DETAILED ON ARCHITECTURAL DRAWINGS.

CONNECT 1" GAS TO EXISTING ABOVE CEILING AND RISE THRU ROOF.
FLASH WATER TIGHT. DETAIL 4/MP.C.

GAS LINE EXPOSED ON ROOF TO A.C. UNITS. SEE PIPE SUPPORT DETAIL.

(12) 1" GAS TO UNIT WITH GAS COCK.

13) 3/4" CONDENSATE TO A.C. UNIT WITH TRAP.

3/4" CONDENSATE DRAIN EXPOSED ON ROOF. CONNECT TO EXISTING. PLUMBING VENT. FIELD VERIFY. SEE PIPE SUPPORT DETAIL.

EXISTING RELIEF VENT TO REMAIN INCLUDING GRILLE, DUCT, MOTORIZED DAMPER AND ROOF CAP. INTERLOCK WITH A.C. UNIT TO OPEN WHEN UNIT IS ON AND CLOSE WHEN UNIT IS OFF.

19 3/4" CONDENSATE DRAIN CONNECTION AT A.C. UNIT WITH TRAP. DROP THRU ROOF. FLASH WATER TIGHT.

3/4" CONDENSATE IN ATTIC. CONNECT TO EXISTING PLUMBING VENT. FIELD VERIFY FOR EXACT ROUTING.

(21) 1 1/4" GAS TO UNIT WITH GAS COCK.

22) EXISTING GAS INTO BUILDING. DISCONNECT AND CAP BELOW GRADE.

77PICAL SLOCATIONS. PROPERLY DISCONNECT ELECTRICAL.

REMOVE GAS LINE TO BELOW FLOOR. FLUE CAP & FLAGHING TO


REMAIN & ROOF. REPAIR CAPPET AROUND FURNACE.

(24) CAP EXISTING ROOF JACK. SEAL WATER TIGHT. REMOVE EXISTING FURNACE AND MOUNTING FRAME FROM ROOF.

CONNECT 3/4" GAS TO EXISTING ON ROOF. EXTEND ON ROOF TO A.C. UNIT. SEE PIPE SUPPORT DETAIL.

(28) 3/4" GAS TO UNIT WITH GAS COCK.

31) REMOVE EXISTING OUTSIDE AIR GRILLE - CAP DUCT AND REINSTALL GRILLE.

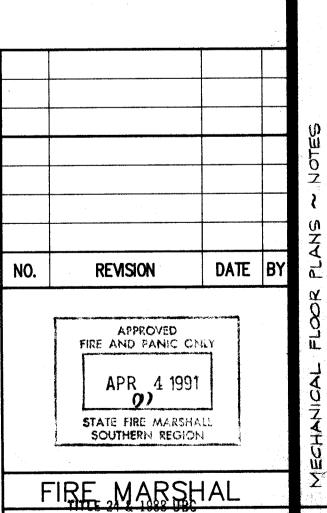



IDENTIFICATION STAMP 142 Office of the State Archite A SHEET NO. APR 4 1001 Structural Safety Section

18 55 8 5 5 66 0

2016.4: 0.S.A.

Q

0/5