CONSTRUC

ARCHITECTURE PLANNING

San Luis Obispo

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PRIME CONSULTANT

ibigroup.com

NO. DATE APPRD.

FERRANTI ENGINEERING

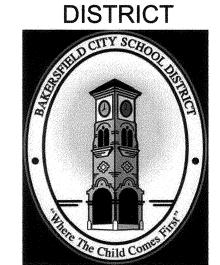
CONSULTING ELECTRICAL ENGINEERS
1211 MARICOPA HWY, SUITE 250 OJAI, CA 93023 (805) 705-4772 DALEFERRANTI@LIVE.COM

AGENCY INFORMATION:

AGENCY TRACKING NO. 63321-241 FILE NO. 15-6

IDENTIFICATION STAMP DIV. OF THE STATE ARCHITECT OFFICE OF REGULATION SERVICES 03-118380 DATE OCT 25 2017

BAKERSFIELD CITY SCHOOL



BESSIE OWENS INTERMEDIATE **RELOCATABLES** A101 - A106

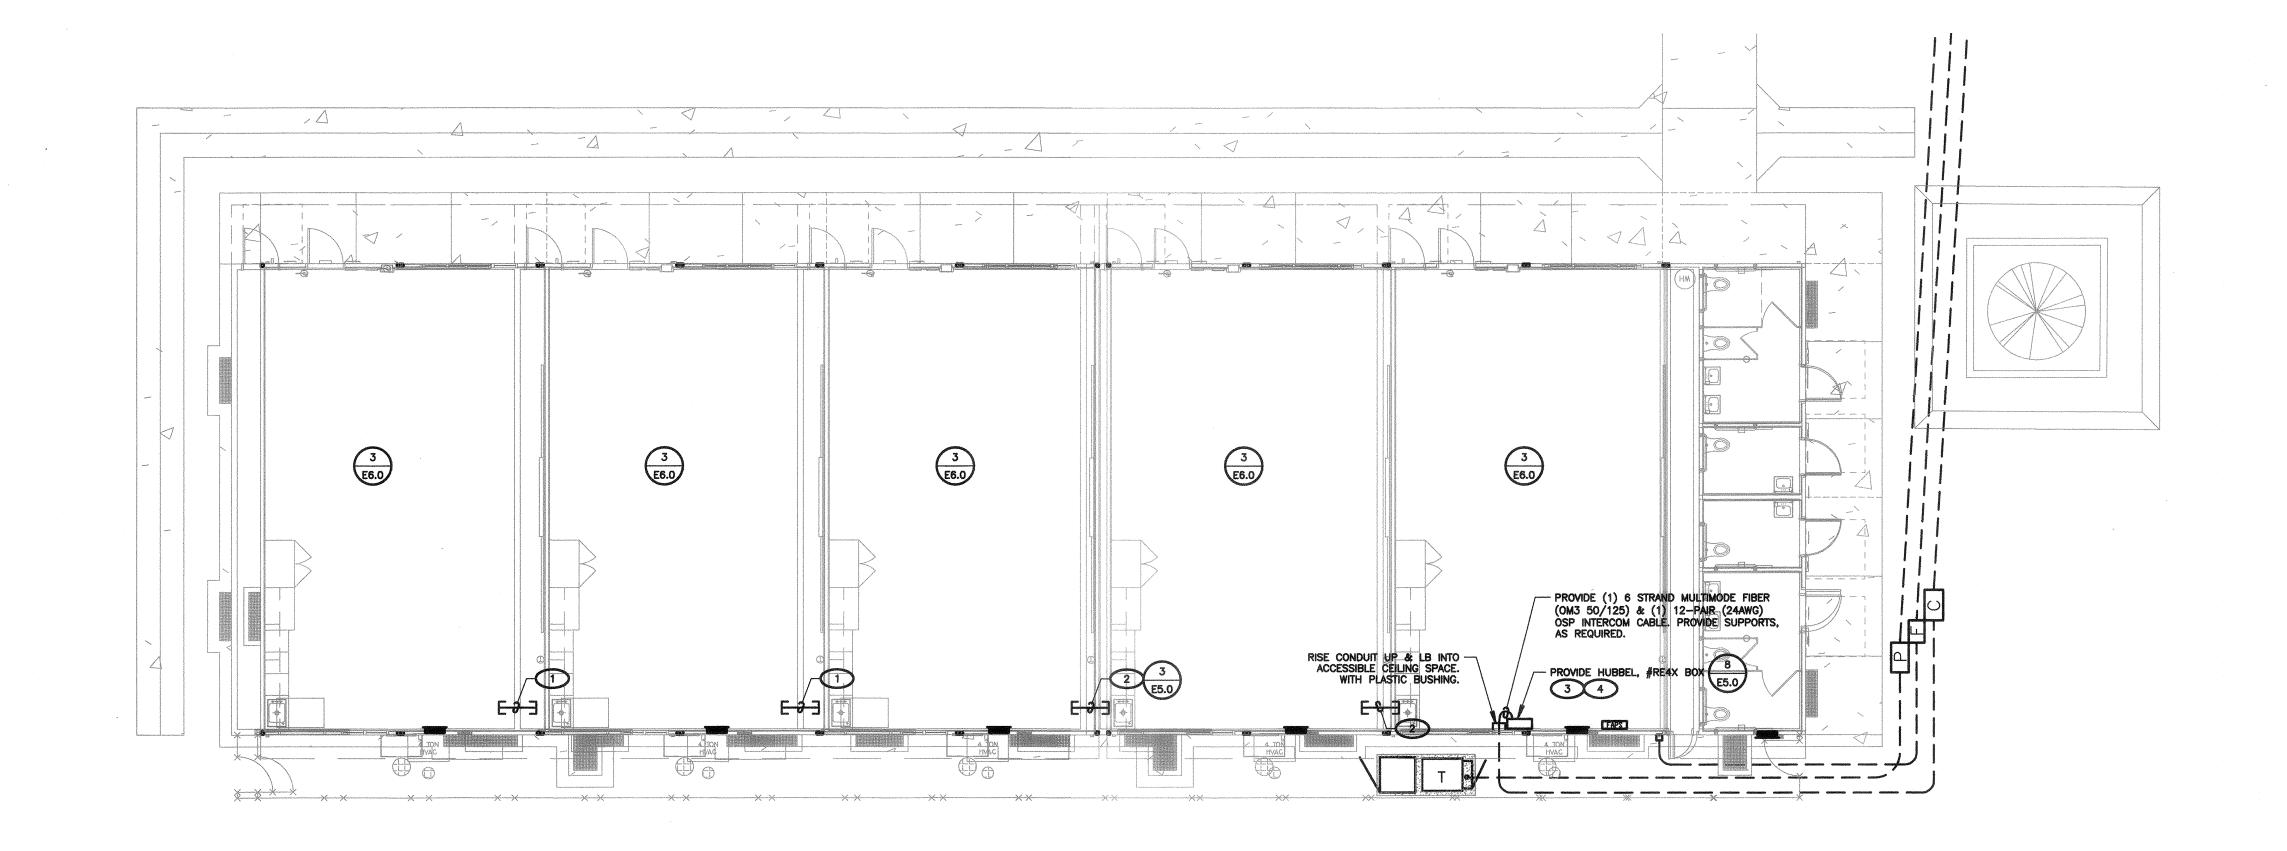
815 EUREKA ST. BAKERSFIELD CA, 93305

OPSC or OSHPD PROJ. NO: PROJECT NO: 16241.000 DRAWN BY: ٧Z CHK'D BY: DF ISSUE DATE: 8/29/2017 SHEET TITLE

RELO SIGNAL PLAN AND **RELO POWER PLAN**

SHEET NUMBER

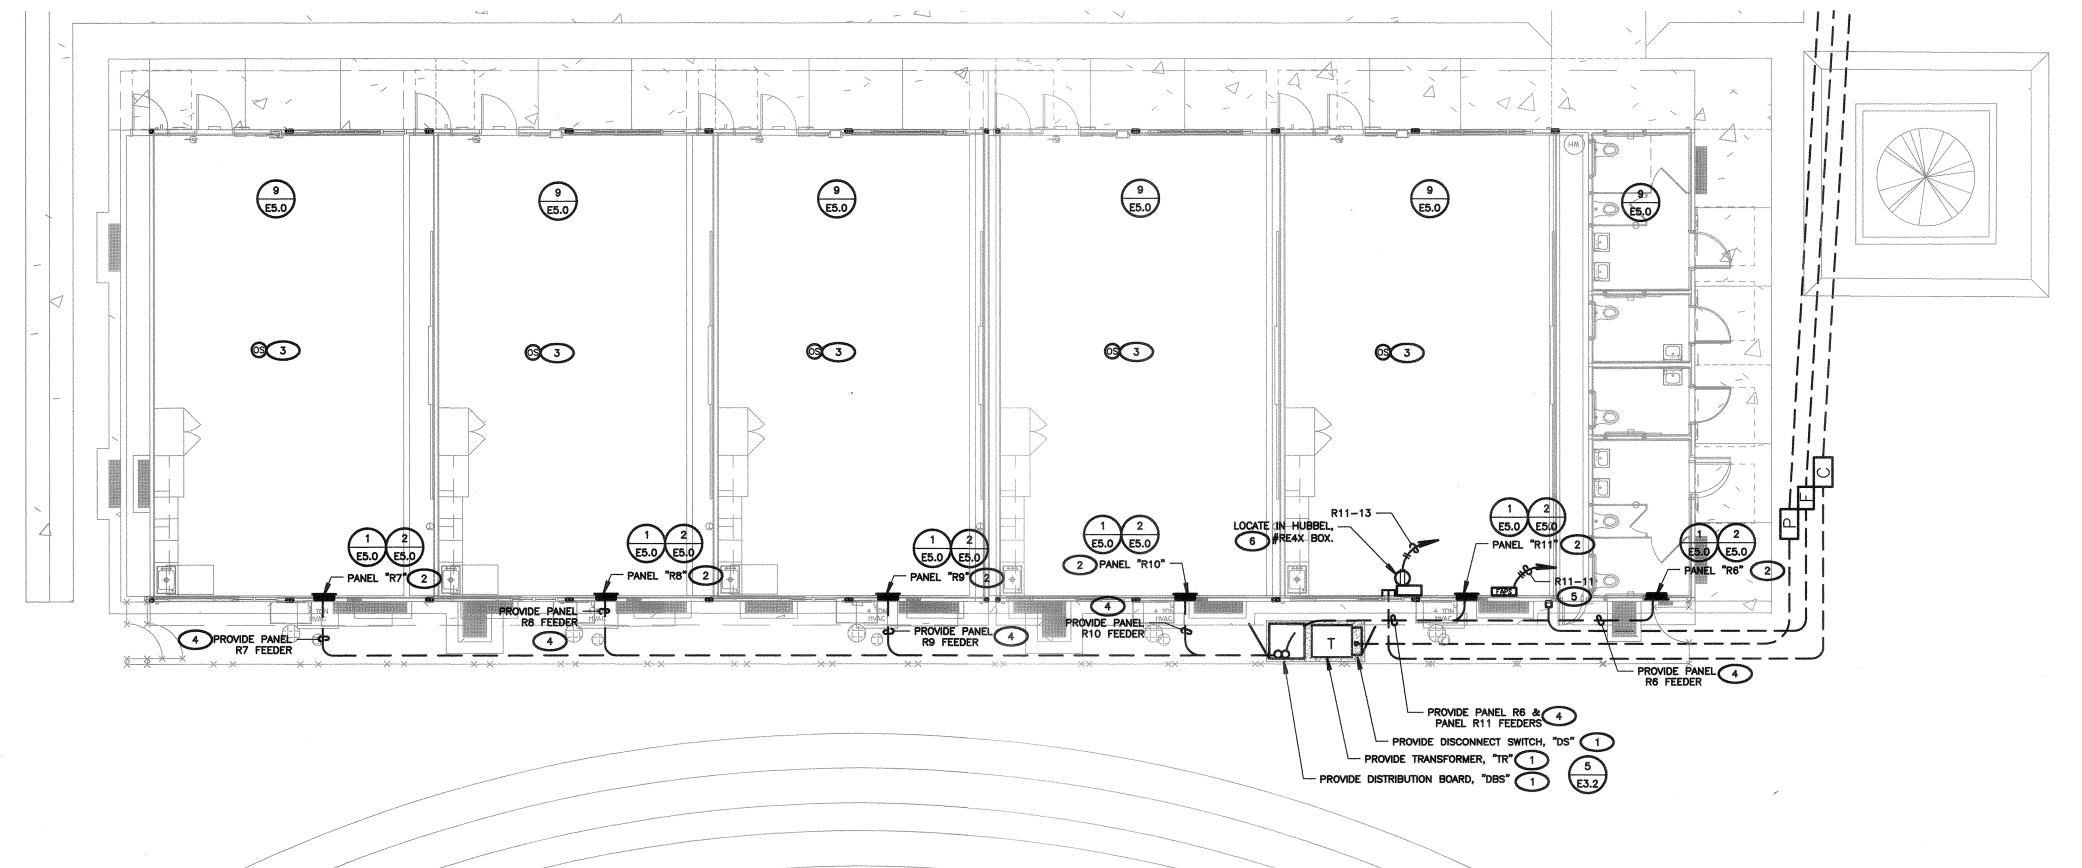
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RELO SIGNAL PLAN (A101-A106)

RELO POWER PLAN (A101-A106)

SCALE: 1/8"=1'-0"



Know what's below.

Call before you dig.

BRANCH CIRCUIT LOAD CENTER PROVIDED BY MODULAR CLASSROOM MANUFACTURER. SEE MODULAR CLASSROOM SHOP DRAWINGS FOR PANEL SCHEDULE. VERIFY LOCATION & PROVIDE CONNECTION PER VENDOR'S SHOP DRAWINGS.

PROVIDE ALL NECESSARY WORK & MATERIALS IN ORDER TO INTERCEPT EXISTING LIGHTING BRANCH CIRCUIT TO PROVIDE TITLE 24 COMPLIANT OCCUPANCY SENSOR CONTROL. PROVIDE ALL REQUIRED RELAYS, POWER PACKS, & SENSORS FOR A COMPLETE SYSTEM

POWER PLAN KEY NOTES

1 REFER TO SINGLE LINE DIAGRAM

SIGNAL PLAN KEY NOTES

(NOTE: THESE NOTES MAY NOT APPEAR ON ALL SHE

PROVIDE 2" CO SLEEVE WITH PLASTIC BUSHINGS AT BOTH ENDS IN ACCESSIBLE CEILING SPACE.

PROVIDE (2) 2" CO SLEEVE WITH PLASTIC BUSHINGS AT BOTH ENDS IN ACCESSIBLE CEILING SPACE.

PROVIDE PATCH PANELS IN #RE4X BOX & TERMINATE ALL DATA CABLES.

PROVIDE ALL REQUIRED WORK & MATERIALS IN ORDER TO CONNECT 6 STRAND MULTIMODE FIBER.

FOR FEEDER INFORMATION REFER TO SINGLE LINE DIAGRAM.

PROVIDE (1) 20/1P CIRCUIT BREAKER IN EXISTING SPACE OR USE SPARE 20/1P CIRCUIT BREAKER. THE CIRCUIT BREAKER SHALL HAVE A RED MARKING & BE IDENTIFIED AS "FIRE ALARM CIRCUIT CONTROL". PROVIDE A LOCK-ON DEVICE ON THE CIRCUIT BREAKER HANDLE. CIRCUIT BREAKER SHALL BE PERMANENTLY IDENTIFIED AT THE "FACP" & "EVAC". PROVIDE SURGE SUPPRESSORS ON THE PROVIDE SURGE SUPPRESSORS ON THE INPUT OF CONTROL PANELS, EXCEPT FOR CONTROL PANELS WITH BUILT—IN SURGE SUPPRESSORS.

PROVIDE TVSS TYPE 120V,20A RECEPTACLE. LOCATE IN RE4 XBOX.

POWER SHEET NOTES

CONTRACTOR SHALL VERIFY LOCATION & REQUIREMENTS OF ALL DEVICES REQUIRING ELECTRICAL CONNECTION PRIOR TO BID PROPOSAL, ROUGH—IN AND FINISH.

2. CONTRACTOR SHALL, IN ROUTING ALL CIRCUITS, INCREASE CONDUCTOR & CONDUIT SIZE TO ALLOW FOR VOLTAGE DROP SHOULD THE CONTRACTOR EXCEED ROUTING INDICATED ON DRAWINGS. ENGINEER OF RECORD MUST BE NOTIFIED PRIOR TO ANY DEVIATIONS FROM APPROVED PLAN

3. COORDINATE WORK WITH OTHER TRADES. OBTAIN ALL DRAWINGS THAT WILL REQUIRE COORDINATION AND PROVIDE ALL ELECTRICAL CONNECTIONS, DEVICES, AND WIRING REQUIRED WHETHER SHOWN ON THE ELECTRICAL DRAWINGS

4. CONTRACTOR SHALL FURNISH AND INSTALL PULL BOXES AS REQUIRED TO INSTALL CONDUCTORS PER CONDUCTOR MANUFACTURERS RECOMMENDATIONS, PER THE NATIONAL ELECTRICAL CODE, AND PER LOCAL AUTHORITIES HAVING

5. 3/4" CONDUIT MINIMUM, UON.

6. PROVIDE CODE SIZED EQUIPMENT GROUNDING CONDUCTORS IN ALL OCCUPIED CONDUITS. 7. PROVIDE CONTROLS FOR MECHANICAL EQUIPMENT PER MECHANICAL DOCUMENTS. VERIFY LOCATION AND REQUIREMENTS OF MECHANICAL EQUIPMENT ON

8, VERIFY LOCATION OF ALL DEVICES ON ARCHITECTURAL PLANS.

9. ALL CONDUIT RUNS SHALL BE CONCEALED IN WALLS OR ROUTED ABOVE THE CEILING/ACCESSIBLE CEILING SPACE.

10. ALL PENETRATIONS THROUGH FIRE RATED WALLS SHALL BE PROTECTED FROM THE SPREAD OF FIRE WITH AN APPROVED FIRESTOP SYSTEM EQUAL TO OR GREATER THAN THE RATING OF THE WALL.

11. MOUNTING HEIGHT OF ALL RECEPTACLES AT COUNTER TOPS SHALL BE VERIFIED WITH OWNER/ARCHITECT PRIOR TO ROUGH-IN.

12. PROVIDE GFCI TYPE RECEPTACLE WITHIN 6 FEET OF ANY

13. CONTRACTOR SHALL PROVIDE A PERMANENT MARKING IN ORDER TO DIFFERENTIATE OCCUPANCY CONTROLLED RECEPTACLES FROM THE UNCONTROLLED RECEPTACLES. VERIFY ACCEPTABLE MEANS OF PERMANENT MARKING WITH THE AHJ.