



2 TYPICAL CLASSROOM REAR END WALL ELEVATION


	ROOM F	INI	SH	IES	SC	CHE	EDI	UL			DOOR SCHEDULE													
FINISHES											DOORS								FRAMES					
ROOM NUMBER	1 1 4 4 4 1 1 1 1 1 1 1 1 1 1 1		BASE	FRONT		RIGHT	LEFT	CEILING	CEILING HEIGHT	REMARKS	DOOR NO.	I FRAME OPENING			MATERIAL FIRE RATING HARDWARE SET NO.			QUANTITY	MATERIAL	HEAD DETAIL	JAMB DETAIL	REMA	RKS	
<u>ĕ</u>	CLASSROOM	> FLOOR	D	F	F	E F		13	8'-6"		- 0	* 3'	0" x 7'-	∙o"	НМ		Α	2	STL	9/A4A	4/A4A	*P/ HARI	ANIC OWARE	
т.		+~-	-	<del> </del>	<del>                                     </del>	<u> </u>	╁	<del>  `</del>	-		2	3'-	0" × 7'-	0"	НМ		Α	1		9/A4A	<del></del>			
		<b>-</b>		<b>†</b>	1			1			3	2'-	0" × 7'-	·0"	НМ		A		STL	9/A4A	4/A4A			
***************************************		<u> </u>		ļ		ļ	ļ									·							<u> </u>	
		ļ	<u> </u>	<del> </del>			<del> </del>	ļ			_				******						<del></del>		·····	
											AL SST STL WWF SC HC	SST - STAINLESS STEEL  STL - STEEL FRAME. 16 ga. FULLY WELDED *CLASSROOMS > 1000 S.  WWF - WINDOW WALL FRAME WILL RE'Q PANIC HARDW.  SC - SOLID CORE WOOD PER CBC 1008.1.9												
A - CARPET PER STATE OF CALIF SPEC COMPLYING WITH GROUP 1, TYPE A OR TYPE B, CLASS 2, DENSITY 4600, DIRECT GLUE DOWN.										WINDOW SCHEDULE														
B - VINYL SHEET FLOORING C - VCT. ARMSTRONG STANDARD OR EXCELON D - TOP SET BASE. 4" BURKE											WINDOW	NO. AMT.	<b></b>	WIDTH	<del> </del>	GHT	FINIS	SH	GLA	ASS TYF	E U-	FACTOR	SHGC	
E - TOP SET BASE. 6" BRINGANTINE OR SANDOVAL												1	SLIDER	6'-0"	4'-	-0"	BRON	IZE	SOI	LAR GR	AY O	.780	0.430	
F - WALL FINISH. 1/2" VINYL TACKBOARD CLASS 1 OVER 1/2" GYP BOARD BACKING G - 1/2" W.R. GYP BOARD. TAPE, TEXTURE, PAINTED FINISH												1	SLIDER	4'-0"	4'-	-0"	BRON	IZE	soi	LAR GR	AY O	.780	0.430	
H - 1/2 I - 3/3 J - ACC K - 1/2	H - 1/2" GYP BOARD. TAPE, TEXTURE, PAINTED FINISH  I - 3/32" F.R.P. OVER 1/2" GYP BOARD  J - ACOUSTICAL LAY IN GRID CEILING PANELS (SEE SPECIFICATIONS)											EXTERIOR LITE - 3/16" MINIMUM TEMPERED GLASS OR LAMINATED AS - 1 GLASS OF SOLAR GRAY GLARE REDUCING TYPE WITH A LIGHT TRANSMISSION FACTOR OF 45% MAXIMUM.												

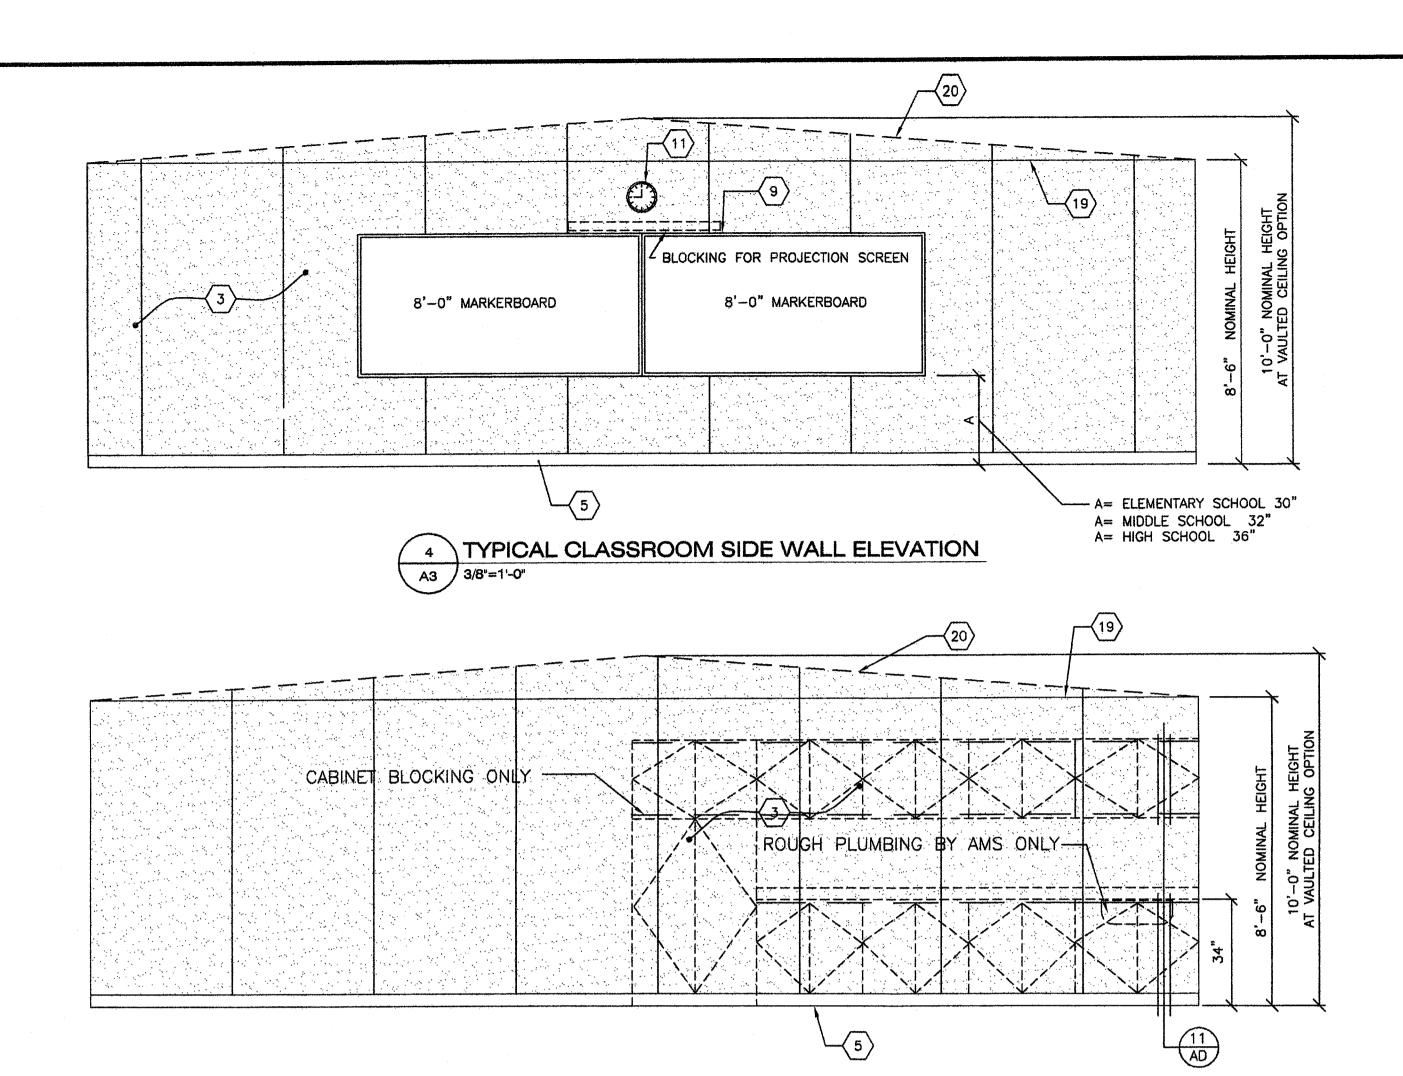

3 TYPICAL CLASSROOM SIDE WALL ELEVATION

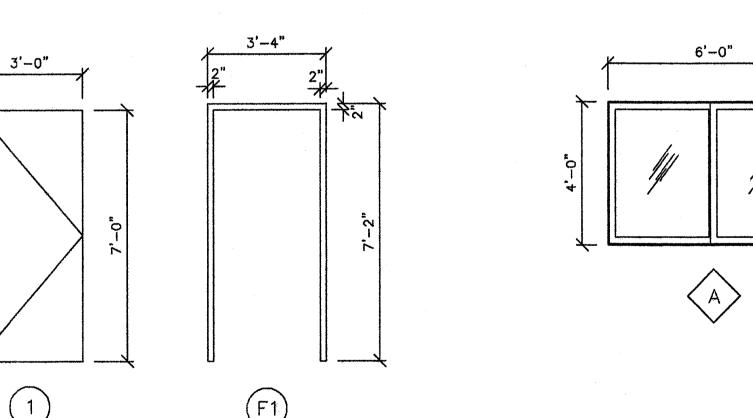

A3 3/8"=1'-0"

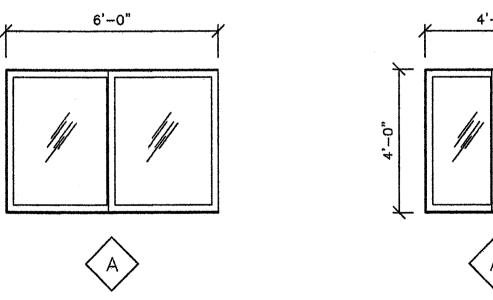

6 WINDOW TYPES
A3 3/8"=1'-0"

REVISIONS NO DATE DESCRIPTION

DATE:07/02/09 SCALE: NOTED DRAWN BY: DM SERIAL NO.:


CUSTOMER:


BAKERSFIELD CITY SCHOOL DISTRICT FREMONT ELEMENTARY SCHOOL


2 1/2:12 PITCHED ROOF 30' x 32' RELOCATABLE BUILDINGS TYPICAL INTERIOR ELEVATIONS




5 DOOR AND DOOR FRAME TYPES

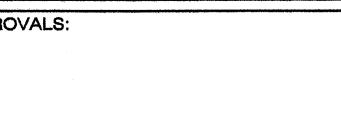

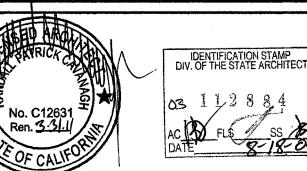

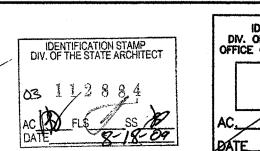

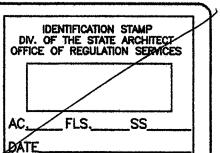

PROJECT No.

- KEY NOTES -

1 WINDOW TYP.

4 TYP MOD LINE

5 TOP SET BASE

 $\sqrt{7}$  NOT USED

(11) CLOCK

2 TYP EXTERIOR DOOR

3 VINYL WRAPPED TACKABLE WALLS

 $\langle 6 \rangle$  TRIM PIECE (FIELD INSTALL)

9 (2) 4'x8' MARKER BOARDS

8 ELECTRICAL PANEL (LOCATION MAY VARY)

PULL STATION J-BOX 48" A.F.F SEE ELECTRICAL SHEETS

13 HORN/STROBE J-BOX SEE ELECTRICAL SHEETS

16 THERMOSTAT 48" A.F.F SEE MECHANICAL SHEETS (LOCATION MAY VARY)

18 TYP DUPLEX OUTLET (SEE ELECTRICAL SHEETS)

(14) LIGHT SWITCH SEE ELECTRICAL SHEETS

EXIT TACTILE SIGN
PER DETAIL 10/AD (BY OWNER)

FIRE EXTINGUISHER TOP OF BRACKET @ +48" AFF PROTRUSION MAX 4" FROM WALL. IF HIGHER THAN 27" A.F.F

(19) FLAT CEILING @ 8'-6" NOM.

20 OPTIONAL VAULTED CEILING

10 HVAC GRILL (LOCATION MAY VARY)

BASED ON PC# 02-109701